MERIDIAN CENTRAL ESTATE - STAGE 41

BROWNS PROPERTY PTY, LTD. CITY OF CASEY

CONSTRUCTION NOTES

SITE MANAGEMENT

- A1. Prior to commencement of works on site, the contractor must ensure that all matters relating to the Occupational Health & Safety Act 2004, including all relevant regulations, have been addressed. In particular, the required notifications must be conveyed to the Victorian Workcover Authority - Health & Safety division with respect to trenching operations. Details of the contractors occupational health & safety procedures must be lodged with the superintendent prior to commencement of works.
- A2. All native trees & shrubs to be retained unless road construction necessitates their removal or removal is directed by the engineer. A town planning permit is required for the removal of native trees & / or vegetation. The removal or retention of any existing trees must be in accordance with the approved landscape plan, or else approval will be required from the City of Casey landscape approvals officer.
- A3. Existing dam or watercourses to be excavated to a firm base & backfilled as specified. Consulting engineer to be notified when the dam or watercourses are excavated to a firm base. No filling is to be placed prior to dams being inspected & levels taken. Backfilling is to be carried out to the satisfaction of the Council supervising engineer.
- A4. Prior to commencement of works, the contractor must submit a Site Management Plan (SMP) to the consultant for approval. The contractor must comply with the recommendations of the Environment Protection Authority publication No.275 "Construction techniques for sediment pollution control". Appropriate siltation control is to be maintained throughout the construction & maintenance period of the works.
- A5. Provide temporary safety barrier fence (Farm Fence as per MW Std Dwg 7251/4/203) along extent of outfall drain where the drain is greater than 1.5m in depth & side slopes are steeper than 1 in 3. Safety fence to remain until permanent underground drainage is installed.
- A6. Contractor to remove existing irrigation & drainage pipes & pits encountered on site. Trenches to be backfilled in accordance with notes C2 & C3.
- A7. An environmental management plan (EMP) must be submitted to and approved by Council prior to the commencement of any works on site and all works must be carried out in accordance with this EMP.
- A8. A traffic management plan (TMP) must be submitted to, and approved by Council prior to the commencement of any works on site and all traffic management must be carried out in accordance with this TMP.

- B1. All works to be carried out in accordance with AS2124-1992 general conditions of contract & the City of Casey and EDCM current specification & standard drawings & to the satisfaction of
- B2. Council to be notified two (2) clear days prior to commencement of works.
- B3. Before commencement of works on trenches in excess of 1.5m deep, the civil contractors construction supervisor must give notice in writing of such proposals to Worksafe Victoria in accordance with Part 5.1, Division 4 of the Occupational Health & Safety regulations (2007) & undertake safety precautions in trenching operations in accordance with Workcover's code of
- B4. Lots to be graded (1 in 150 min slope) & left clean to the satisfaction of the engineer. Finished levels to be compatible with lots adjoining this stage.
- B5. On completion the contractor is responsible for the removal of all rubbish & spoil from site. No surplus trees, vegetation or other material is to be burnt on site.
- B6. Reserves to be free draining & to be left in a condition satisfactory to the City of Casey works Where works are in the vicinity of existing services these services are to be located & the

various authorities notified prior to the commencement of works.

re-instatement at the contractors expense.

- B8. All TBM's & control points are to be maintained & protected at all times during construction. Should any marks be disturbed, the contractor will immediately notify the consultant to arrange
- B9. Provide painted paling fence along any boundary common to lots & municipal reserves as per Council Std. Dwg. S-706. Palings to be on the reserve side.
- B10. As constructed plans and electronic asset information in D-Spec and R-Spec format must be submitted to Council prior to practical completion
- B11. Temporary crushed rock turn around areas must be maintained in a safe and sound condition so that vehicles are able to use them at al times.

ROADWORKS

- C1. 100ø agricultural pipe drains (MPA standard drawing EDCM 202) to be placed behind all kerb & channel & buffer pitchers & where directed by the engineer.
- C2. Filling in all properties & road reserves is to be carried out using approved clay fill. Top soil & all vegetable matter to be stripped from site prior to filling. All filling to be carried out in accordance with AS3798-2007 and the geotechnical report. Level 1 inspection and testing to be carried out in accordance with AS3798-2007 Section 8.2. A fill report must be submitted to the Consultant, showing from a NATA registered soil testing laboratory.
- C3. Importing Fill:- All imported fill must be tested by a NATA approved laboratory to ensure it is suitable for use on site, & any contaminates are within accepted levels. Under no circumstances should fill material enter or leave the site without the permission of the supervising engineer & Council works supervisor, prior to it being appropriately tested. All vehicles transporting fill material to & from the site must have appropriate measures in place to ensure that material does not get onto roads & into stormwater systems & natural waterways.

- C4. Batters to be 1 in 5 for fill & 1 in 3 for cut unless noted otherwise.
- C5. Cut batters are to be grassed & mulched with a mixture of chopped grass, straw & bitumen
- C6. Where cut batters exceed 700mm an additional 300mm berm shall be formed behind footpath.
- C7. Access ramps are to be constructed where cut batters exceed 1.0m. They are to be graded 1.0m. in 10 for the first 2.5m from the back of path & then at a maximum of 1 in 4 to natural surface.
- The water conduit offset from the lot boundary is given on the water reticulation plan. The contractor must construct conduits to accord with the given offset & ensure that the concreter marks the kerb & footpath exactly above the conduit.
- Irrigation conduits are to be DN100 DWV PVC installed beneath the pavement and/or capping layer, if present. Locations are to be marked using a green dot spray painted on the top of kerb.
- C10. All footpaths are to be 125mm thick 25MPa concrete with SL72 mesh centrally located in accordance with the MPA standard drawing EDCM 401.
- C11. NBN Co to be notified seven (7) days prior to concrete works being placed.
- C12. Electrical distribution pits within footpaths are to be a minimum of 300mm within the edge of the path. Concrete is to be placed around distribution pits to a minimum depth of 200mm.
- C13. All street signs to be constructed & erected to current City of Casey standards including logo Court street names are to show court name only.
- C14. Traffic control signs, markings & delineators to be installed in accordance with AS1742.2. All line marking is to be long life road marking, with longitudinal lines in thermoplastic & transverse markings in cold applied.
- C15. Driveways to be constructed in accordance with the MPA standard drawings EDCM 501 & EDCM 502. Single driveways to be a minimum 3.5m wide & to be offset 0.75m from side boundary or easement unless otherwise shown.
- C16. Kerb transition to take place in the minor street over a 2.0m length from either the tangent point
- C17. Existing road works to be reconstructed as required to provide, without discontinuity, a connection in accordance with design levels & grades.
- C18. Provide 2.5m wide shared footpath through reserves as shown on a curvilinear alignment to the satisfaction of the engineer.
- C19. Tactile ground surface indicators (TGSI) are to be installed at all pram crossings & pedestrian cross points in accordance with AS1428.4 : 2002 & MPA standard drawing EDCM 403.
- C20. If any existing substandard filling is encountered on the site it must be removed and replaced with approved fill material properly compacted to Council requirements. A geo-technical report must be submitted showing details of depth, type of material and density of the fill areas

DRAINAGE

manufacturer's specification.

- D1. Drainage & pits to be set out from offsets shown rather than from centreline pipe chainages. Centreline of pits at TP's to be offset 1.00m.
- D2. Terra Firma or fibreglass type pit lids are required for all drainage pits & all grates for pits are to AS3996 unless otherwise shown. All drainage works are to be be Class D, to comply with constructed to council specifications.
- D3. All pipes up to and including 750mm in diameter shall be rubber ring jointed (RRJ). Pipes above this size may be flush jointed with external sealing bands. For pipes greater than 900mm and changes in direction between 2 connecting pipes exceeding 10° construct
- D4. All pipes to be Class '2' R.C. rubber ring joint unless noted otherwise. PVC pipes to be Class

segmented curves using splayed pipes with bandage joints, having deflections within the

- D5. Pipe trenches beneath the road pavement, footpath or within 150mm of the kerb & channel to be backfilled with 20mm Class 3 FCR in 150mm layers.
- Property inlets to be constructed as per MPA standard drawing EDCM 701 EDCM 704.
- D7. All proposed drainage stubs to be blanked off at end of pipe with timber planks to the satisfaction of the supervising engineer
- D8. A CCTV report must be provided for all drainage lines prior to issue of practical completion.

E1. Modification of the pavement requires approval by the City of Casey works supervisor.

TEMPORARY DRAINAGE FACILITY NOTES

1. All construction to be in accordance with Melbourne Water corporation & City of Casey standard drawings & specifications.

- All drains to be nominal size RC pipes unless shown otherwise.
- Pipe connections to pipeline to be as per Melbourne Water corporation standard drawing
- Pipe bedding & backfill to be as per Melbourne Water corporation standard drawing 7251/4/301
- All coordinates are to local datum.
- All levels are to Australian Height Datum (AHD).
- The location of existing services should be determined by the contractor prior to commencing any excavations by contacting all local service authorities. Any existing services shown on the drawing are offered as a guide only & are not guaranteed as correct.
- The contractor when in engaged in blasting shall not blast within 4.5m of any existing line of water, gas or sewer pipes or within 15m of any completed part of the works without consent of the superintendent.
- The contractor is to ensure that his construction procedures & standards control the volume & location for collection of sediment discharge according to current best practices. This includes the erection of silt fences & silt collection measures such as hay bales & other approved
- Upon completion of construction the whole site shall be cleaned up, graded & all rubbish removed. The site is to be left in a clean & tidy condition to the satisfaction of the superintendent.
- Inlets shall be sealed with close boarded hardwood except those connected to existing drains.
- All exposed earth surfaces to be top soiled to a minimum thickness of 75mm & grassed at the completion of the contract.
- Existing open water course to be kept clear of obstructions to allow flows to discharge without
- 14. If stable rock invert is encountered on site, grouted rock work shall not be required.
- Before commencing work on drains in excess of 1.5m deep, a notice of such a proposal is to be sent to the Occupational Health & Safety Authority in accordance with Clause 202 of the Mines (Trenches) Regulations. The contractor shall erect & maintain all shoring, planking & strutting, the watering devices, barricades, signs, lights etc, necessary to keep works in a safe & stable condition, & to protect the public from hazards associated with the works
- Grassing of reserve to be carried out using "freeway mix" or similar approved which is made up

or the following grasses.		
	by count	
Jazz rye		19
Citation FL rye		18
Duet FL rye		18
Annual rye		23
Tudor CR red fescue		9
Kentucky blue		12
O'connors strawberry		1
Nutricote slow release ferti	lizer	(10)
Total		100 (110)

- 5 clear days notice prior to the commencement of the works must be given to program leader surveillance, waterways, Melbourne Water (ph. 03 9235 2171).
- Filling to be carried out in 150mm layers & compacted to the requirements of the specification. Testing to be carried out as advised by the superintendent.
- Bottom step iron to be located 300mm max from invert of pipe.
- Geotechnical testing of outlet embankment fill material must be carried out by a NATA accredited laboratory and include assessment of fill suitability for prevention of piping failure.
- Outlet embankment is to have select fill compacted in max. 300mm layers to 95% MMDD with moisture content at OMC to +2%
- The project area contains hazardous services including underground fibre optic cables & other communication cables, & overhead electrical cables. For assistance in locating underground cables prior to construction please contact a credited plant locator.
- No construction is allowed within 3m of overhead power lines on poles, a "spotter" (safety observer) is required for works within the range 3 to 6.4m of overhead power lines. The contractor is to notify SP Ausnet on 9238 6300 before the commencement of works, written permission must be obtained from SP Ausnet to operate equipment within the area of overhead power lines & a pre-start on site meeting & a risk assessment must be completed.
- The contractor is to liase with property owners & the supervising engineer while construction proceeds through private property. The area of works are to be kept to a minimum. Temporary fencing is to be erected to restrict livestock wandering into works area.
- HDPE Plastic Liner to be 2mm thick. Contractor to ensure liner is laid taut to avoid loose placement or folds. Liner is to be installed from downstream end with 300mm overlap in the direction of the flow. Liner sections are to be heat welded to form impermeable seal. Liner to be tucked down pit walls and any other concrete structures at a minimum 500mm. Liner to be keyed in along top of embankment minimum 700mm deep.

DRAWING INDEX

DRAWING No.	TITLE	REVISION
1801767-41-001	COVER SHEET	С
1801767-41-002	TYPICAL ROAD CROSS SECTIONS	A
1801767-41-003	PAVEMENT MAKEUP & GENERAL DETAILS	В
1801767-41-010	LAYOUT PLAN (SHEET 1 OF 2)	В
1801767-41-011	LAYOUT PLAN (SHEET 2 OF 2)	В
1801767-41-012	SWALE DRAIN LONGITUDINAL SECTION & TYPICAL CROSS SECTION	A
1801767-41-013	TEMPORARY RETARDING BASIN (SHEET 1 OF 2)	В
1801767-41-014	TEMPORARY RETARDING BASIN (SHEET 2 OF 2)	A
1801767-41-100	ROAD LONGITUDINAL SECTIONS AWEIL LANE & BAKOSI CIRCUIT	A
1801767-41-101	ROAD LONGITUDINAL SECTIONS KHILLARI CIRCUIT	A
1801767-41-102	ROAD LONGITUDINAL SECTIONS MUTURU STREET	A
1801767-41-200	ROAD CROSS SECTIONS AWEIL LANE & BAKOSI CIRCUIT	A
1801767-41-201	ROAD CROSS SECTIONS KHILLARI CIRCUIT (SHEET 1 OF 2)	A
1801767-41-202	ROAD CROSS SECTIONS KHILLARI CIRCUIT (SHEET 2 OF 2)	A
1801767-41-203	ROAD CROSS SECTIONS MUTURU STREET (SHEET 1 OF 2)	В
1801767-41-204	ROAD CROSS SECTIONS MUTURU STREET (SHEET 2 OF 2)	В
1801767-41-300	INTERSECTION DETAILS	A
1801767-41-350	SIGNAGE & LINE MARKING PLANS	В
1801767-41-400	DRAINAGE LONGITUDINAL SECTIONS (SHEET 1 OF 4)	A
1801767-41-401	DRAINAGE LONGITUDINAL SECTIONS (SHEET 2 OF 4)	A
1801767-41-402	DRAINAGE LONGITUDINAL SECTIONS (SHEET 3 OF 4)	A
1801767-41-403	DRAINAGE LONGITUDINAL SECTIONS (SHEET 4 OF 4) AND PIT DETAILS	A
1801767-41-404	PIT SCHEDULE AND PIT DETAILS	В

- Areas on which rock is to be placed shall be trimmed as required to provide a finished surface level of rock in accordance with the drawings. any scours or hollows in the surface shall be stripped of organic matter and any unsuitable base material and then filled with compacted crushed rock
- The general concept of rockwork construction is: It should be made up of angular rock (either quarried or broken up field rock) with a
- minimum specific density of 2.4. It must be made up of well sized, well graded, well embedded, well interlocked
- All voids must be sealed to provide stability and resistance to flow velocities and
- infiltrations/ undermining. It should form an interlocking mass of rock in which the larger rocks in the mix are
- All rockwork shall be done to the satisfaction of the Council on-site representative.
- Rocks should finish flush with surrounding ground. Toe and edge rocks should be trenched into in-situ ground. ground should be boxed-out to enable toe and edge rocks to be placed before filter layer and lining
- LINING ROCKS
- Lining rock is the mass rock medium contained by the leading edge rock to armour/protect the given earth surface. With lining rocks the following should be
- A filter/embedment layer should be used underneath (refer note 32). Lining rocks should be well graded to form a tightly sealed rock layer which is free
- of voids and provides resistance to flow velocities ad infiltration/undermining as per the general intent of rockwork mentioned in note 27. In sealing voids consideration should be given to using a smaller graded rock mix (ie. also referred to as an infill mix). Depending on the size of the voids, a 0-150mm infill mix may be appropriate. Depending on rock availability and construction method adopted, sealing of the rockwork may occur as a pre-mix (ie. infill mix is combined with larger lining rocks before placement), or by working the infill mix between the larger rocks as they are
- The contractor should use methods for handling and placement of lining rock that will avoid segregation of the rock sizes. Rocks shall be carefully placed and positioned, not dumped directly.
- Filter/embedment layer
- Granular filter/embedment layers are usually sufficient, however some sandy, dispersive soils may warrant the use of a geotextile filter layer in addition to the granular filter layer. Where a geotextile filter layer is used, special care needs to be exercised in the laying of the rockwork and consideration given to a thinner granular filter/embedment layer over the geotextile layer to prevent damage to the

Use of graded rock - should generally be limited to 0-100mm graded rock. one size

1 Glenferrie Road

Malvern VIC 3144

- With granular filter/embedment layers the following should be considered: Layer thickness - should generally be 100mm or thicker - depending on type of underlying soil (ie. more or less dispersive), rock size, and hydraulic conditions.
- ballast rock is considered ineffective as it does not resist flow infiltration.

THOMPSON'S ROAD SOFRA ROAD SITE l works

City of Casey

- A free draining out being available prior to Statement of

- Drainage in future Stages 42, 43 & 45 may be amended - A TMP approved prior to commencement of works.

 An EMP approved prior to commencement of works. Relevant service authorities notification and approval

Approved By: Ange Dean

Planning Ref: PA21-0174 File No: SEng00300/22

Council Drawing No.: R5956

Date: 19/04/2023

Approval subject to:

SITE PLAN

NOT TO SCALE

MELWAY REF: 135 F4

Survey Origin:

Coordinates are on a local plane datum based upon MGA2020 Zone 55 bearings and truncated MGA2020 Zone 55 co-ordinates at PM77. Heights are to AHD vide Permanent Mark PM 56 (Cranbourne) RL 26.7 Bearing Datum is MGA2020 Zone 55 which has been derived by our GPSnet Survey.

Plane Grid Coordinates to MGA2020 Zone 55 Grid Coordinates Conversion.

(PLANE SHIFT)

(APPLY SCALE FACTOR)

Add + 353,823.586 to Eastings +5,780,840.520 to Northings Scale by 0.999846 at point PM77

> **ISSUED FOR** CONSTRUCTION

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21.11.2022

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ph: 03 9524 8888


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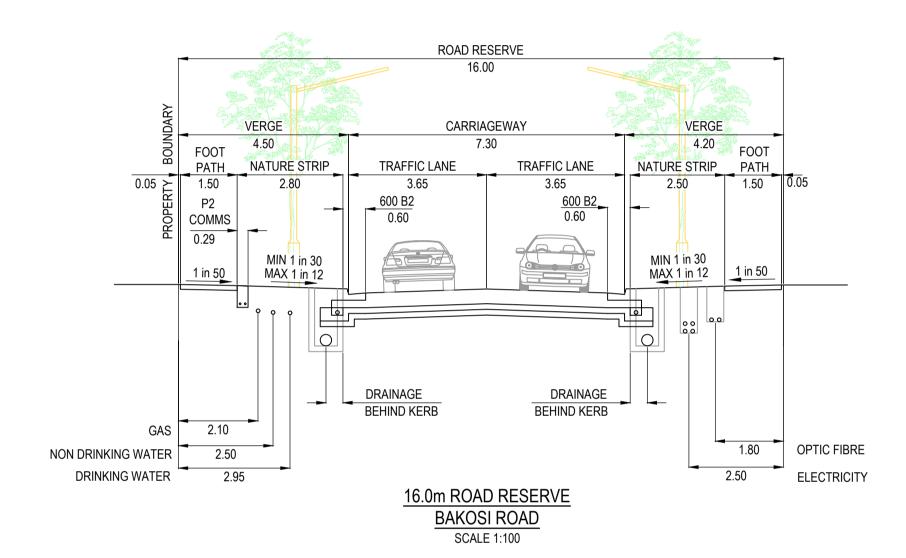
Drawing COVER SHEET


Project Details MERIDIAN CENTRAL ESTATE STAGE 41 CITY OF CASEY


Sheet 01 of 23 Drawing No


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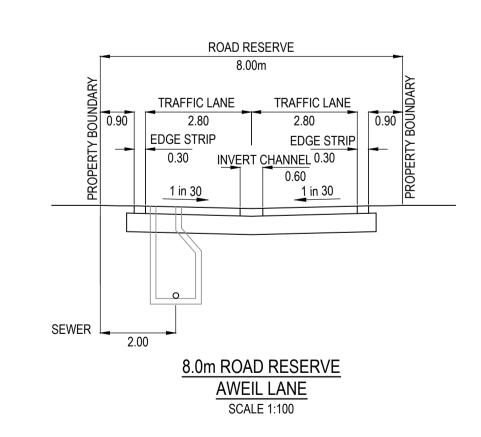




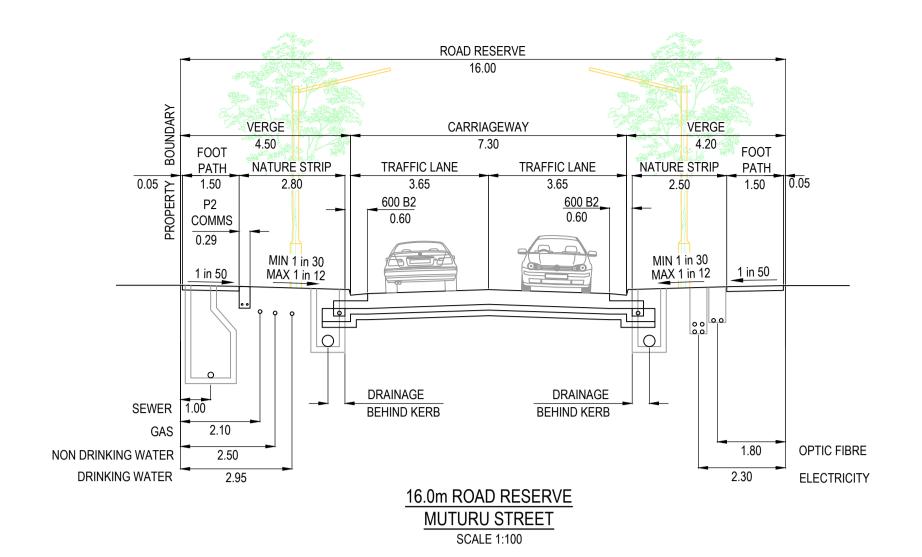

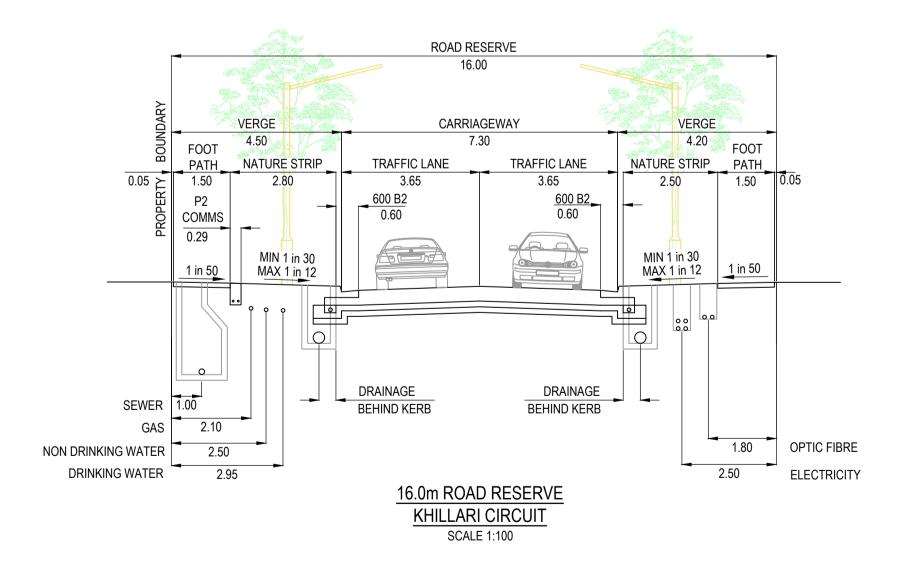

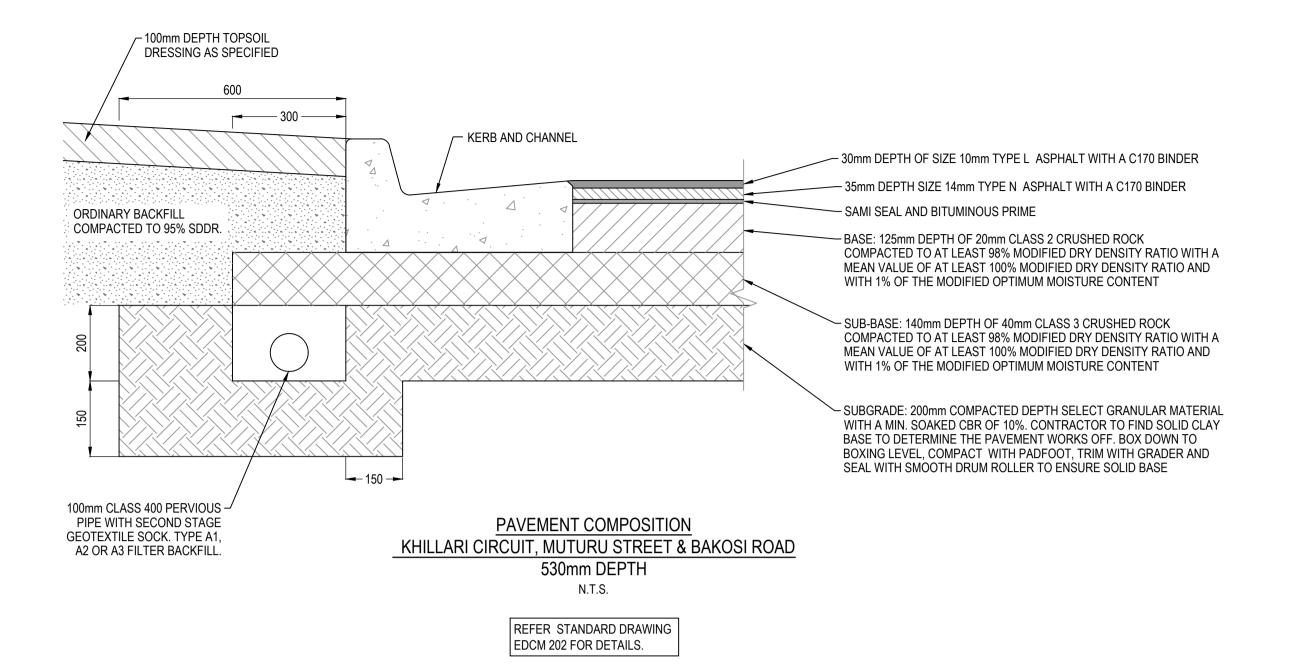

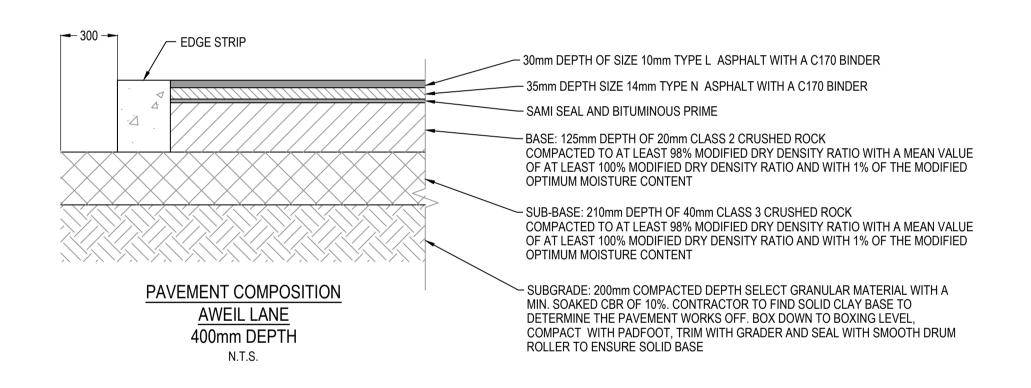

City of Casey

Approved By: Ange Dean Planning Ref: PA21-0174

File No: SEng00300/22

Date: 19/04/2023

Council Drawing No.: R5956

Approval subject to:

- A free draining out being available prior to Statement of

- Drainage in future Stages 42, 43 & 45 may be amended

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- An EMP approved prior to commencement of works. - Relevant service authorities notification and approval

Signed:

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REV	DESCRIPTION	DATE	DRN.	APP.	REV	DESCRIPTION	DATE	DRN.	APP.	





	Designed	C.DAWSON		
	Date	28.10.2022		n e l va <i>t</i> elle
	Drawn	L.SUTHERLAND		Beveridge Williams
ĺ	Checked	M.FELICIANO		_
	Date	21.11.2022		
ĺ	Approved	M.FELICIANO	Developme	ent and Infrastructure Consultant
	Reg. No.	PE0005645		
	Date	21.11.2022	1 Glenferrie Road	ph: 03 9524 8888

ph: 03 9524 8888

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1 Glenferrie Road


Malvern VIC 3144

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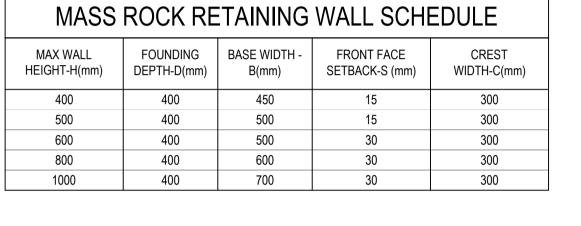
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MASS ROCK RETAINING WALL FOOTING DETAIL

PARALLEL WITH SEWER MAIN (MAX. 600mm HEIGHT)


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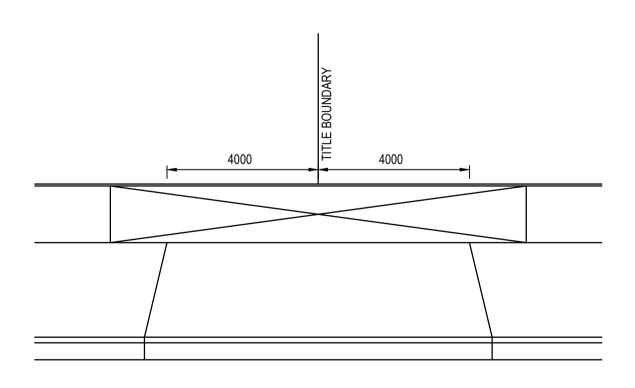
RETAINING WALL NOTE R.1

a. WHERE FOOTPATH ABUTS RETAINING WALL CONTINUE CONCRETE UP TO BASE OF RETAINING WALL.

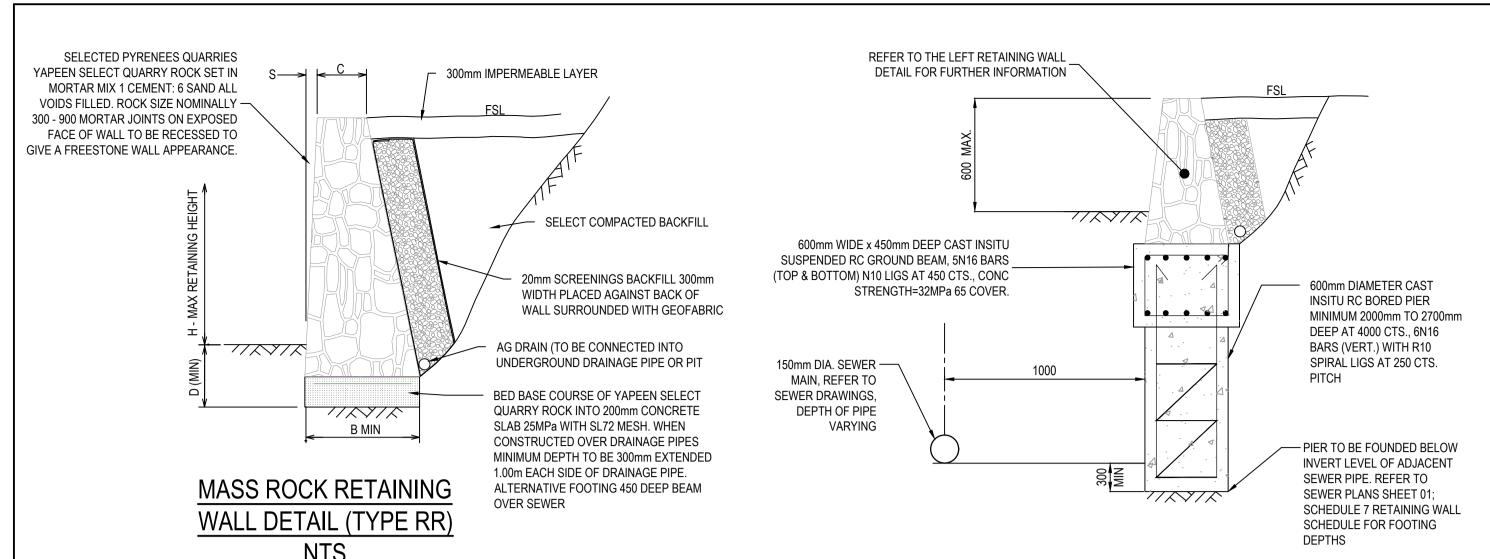- a. TOE OF WALL SHALL PENETRATE THROUGH ANY FILL MATERIAL & THE NATURAL SILT SOILS TO BE FOUNDED AT LEAST 100mm INTO THIS UNDERLYING NATURAL STILL CLAY OR WEATHERED ROCK.
- ALL EXCAVATIONS SHALL HAVE FOUNDING DEPTHS AND BEARING CAPACITY APPROVED BY THE ENGINEER OR BUILDING SURVEYOR BEFORE CONCRETE IS PLACED.
- FOOTING EXCAVATIONS WHICH ARE DEEPEND TO PENETRATE THROUGH UNSUITABLE SOILS SHALL BE BACKFILLED UP TO UNDERSIDE OF FOOTINGS
- WITH 15 MPa BLINDING CONCRETE. b. ALL EXCAVATION FOUNDING SURFACES SHALL BE LEVEL (NOT INCLINED) CLEAN CUT &
- FREE OF MUD OR WATER. c. ALL SEEPAGE INFLOW SHALL BE REMOVED BEFORE PLACEMENT OF CONCRETE.
- d. FOOTINGS SHALL BE FOUNDED IN STIFF NATURAL CLAY HAVING A SAFE BEARING CAPACITY OF 150KPa.




CUT OFF DRAIN TYPICAL SECTION NOT TO SCALE

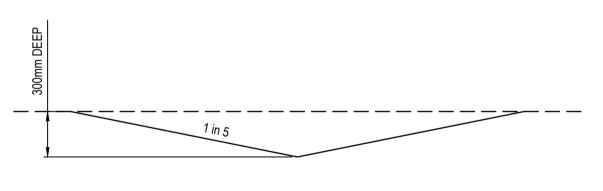



REFER TO EDCM 502 FOR FURTHER DETAILS

8.0m DOUBLE VEHICLE CROSSING DETAIL NOT TO SCALE

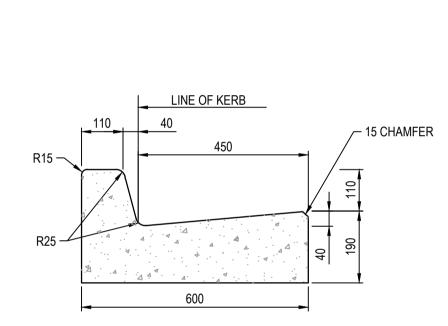


600 WIDE BARRIER KERB (600 B2) DETAIL

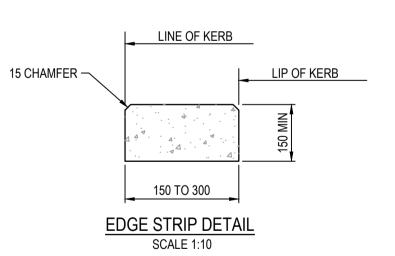

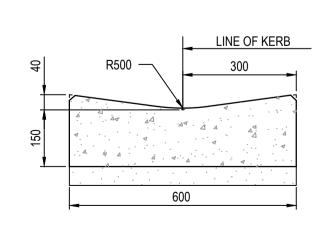

600 WIDE INVERT CHANNEL (600 INV) DETAIL SCALE 1:10

START OF RAMP → 0.50m 0.20m

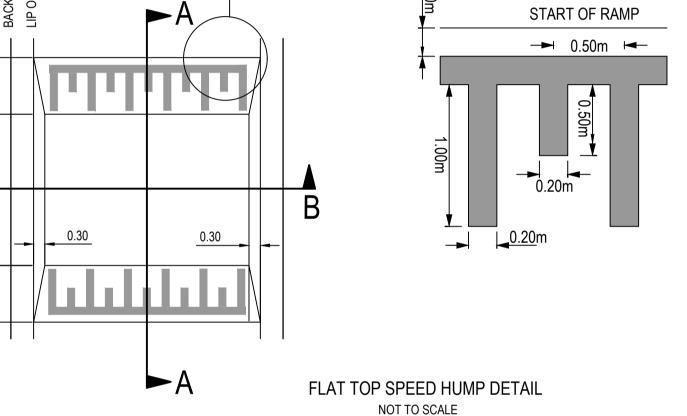

City of Casey

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- Relevant service authorities notification and approval

Approved By: Ange Dean

Planning Ref: PA21-0174


Council Drawing No.: R5956

File No: SEng00300/22

Approval subject to:

Signed:

Date: 19/04/2023

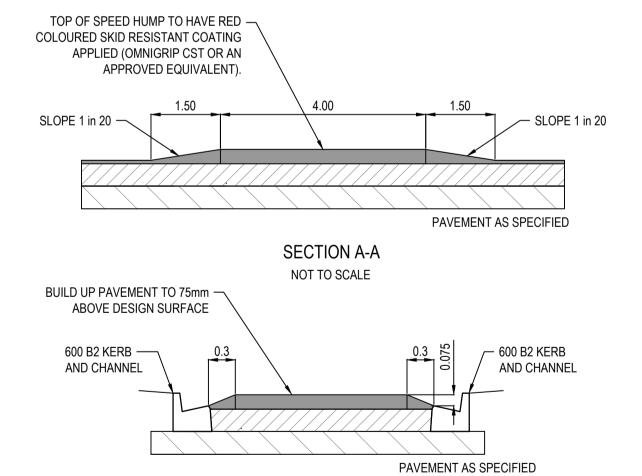

SECTION B-B

NOT TO SCALE

Approved


21.11.2022

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Malvern VIC 3144

Reg. No.




CONCRETE SLEEPER RETAINING WALL DETAILS

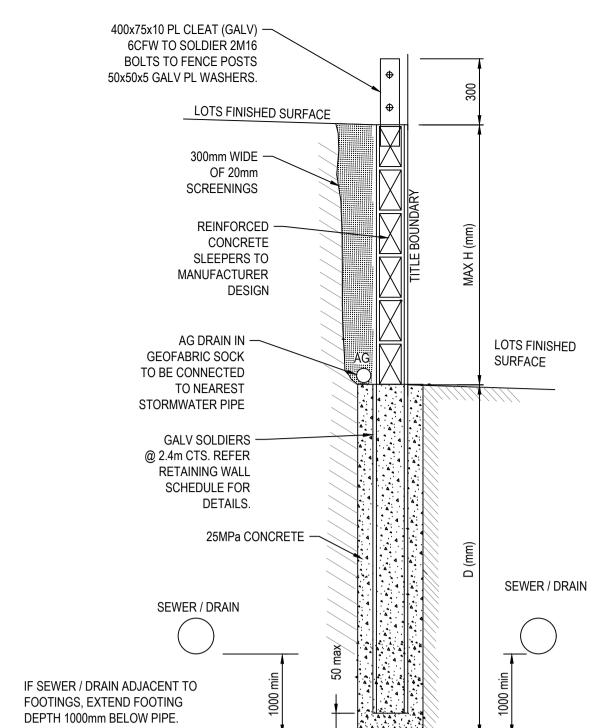300 min

CONCRETE SLEEPER RETAINING WALL SCHEDULE										
HEIGHT - H(mm)	DEPTH - D(mm)	SOLDIERS SIZE @ 2.4m CTS								
600	900	100 UC 14.8								
800	1200	100 UC 14.8								
1000	4500	400 110 44 0								

Dmin TO BE GREATER OF THAT SHOWN ABOVE OR 1000mm BELOW ADJACENT SEWER / FRAINAGE

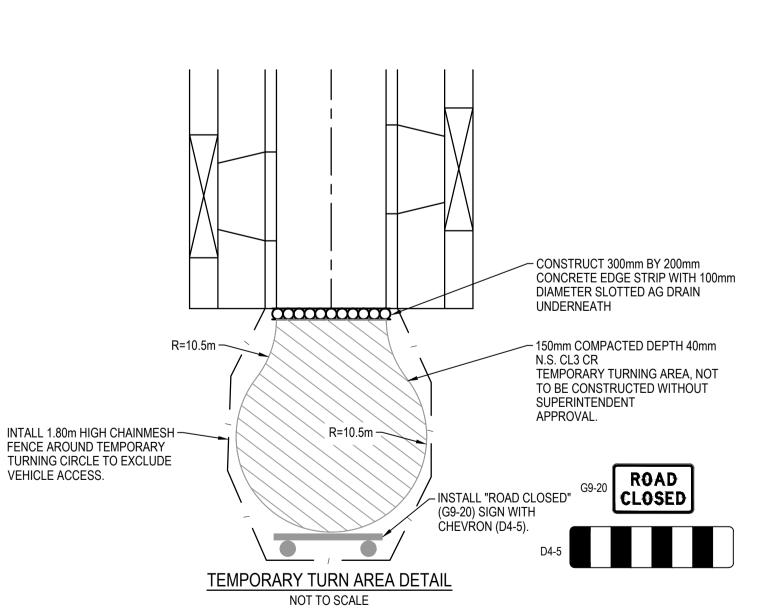

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	28.10.2022
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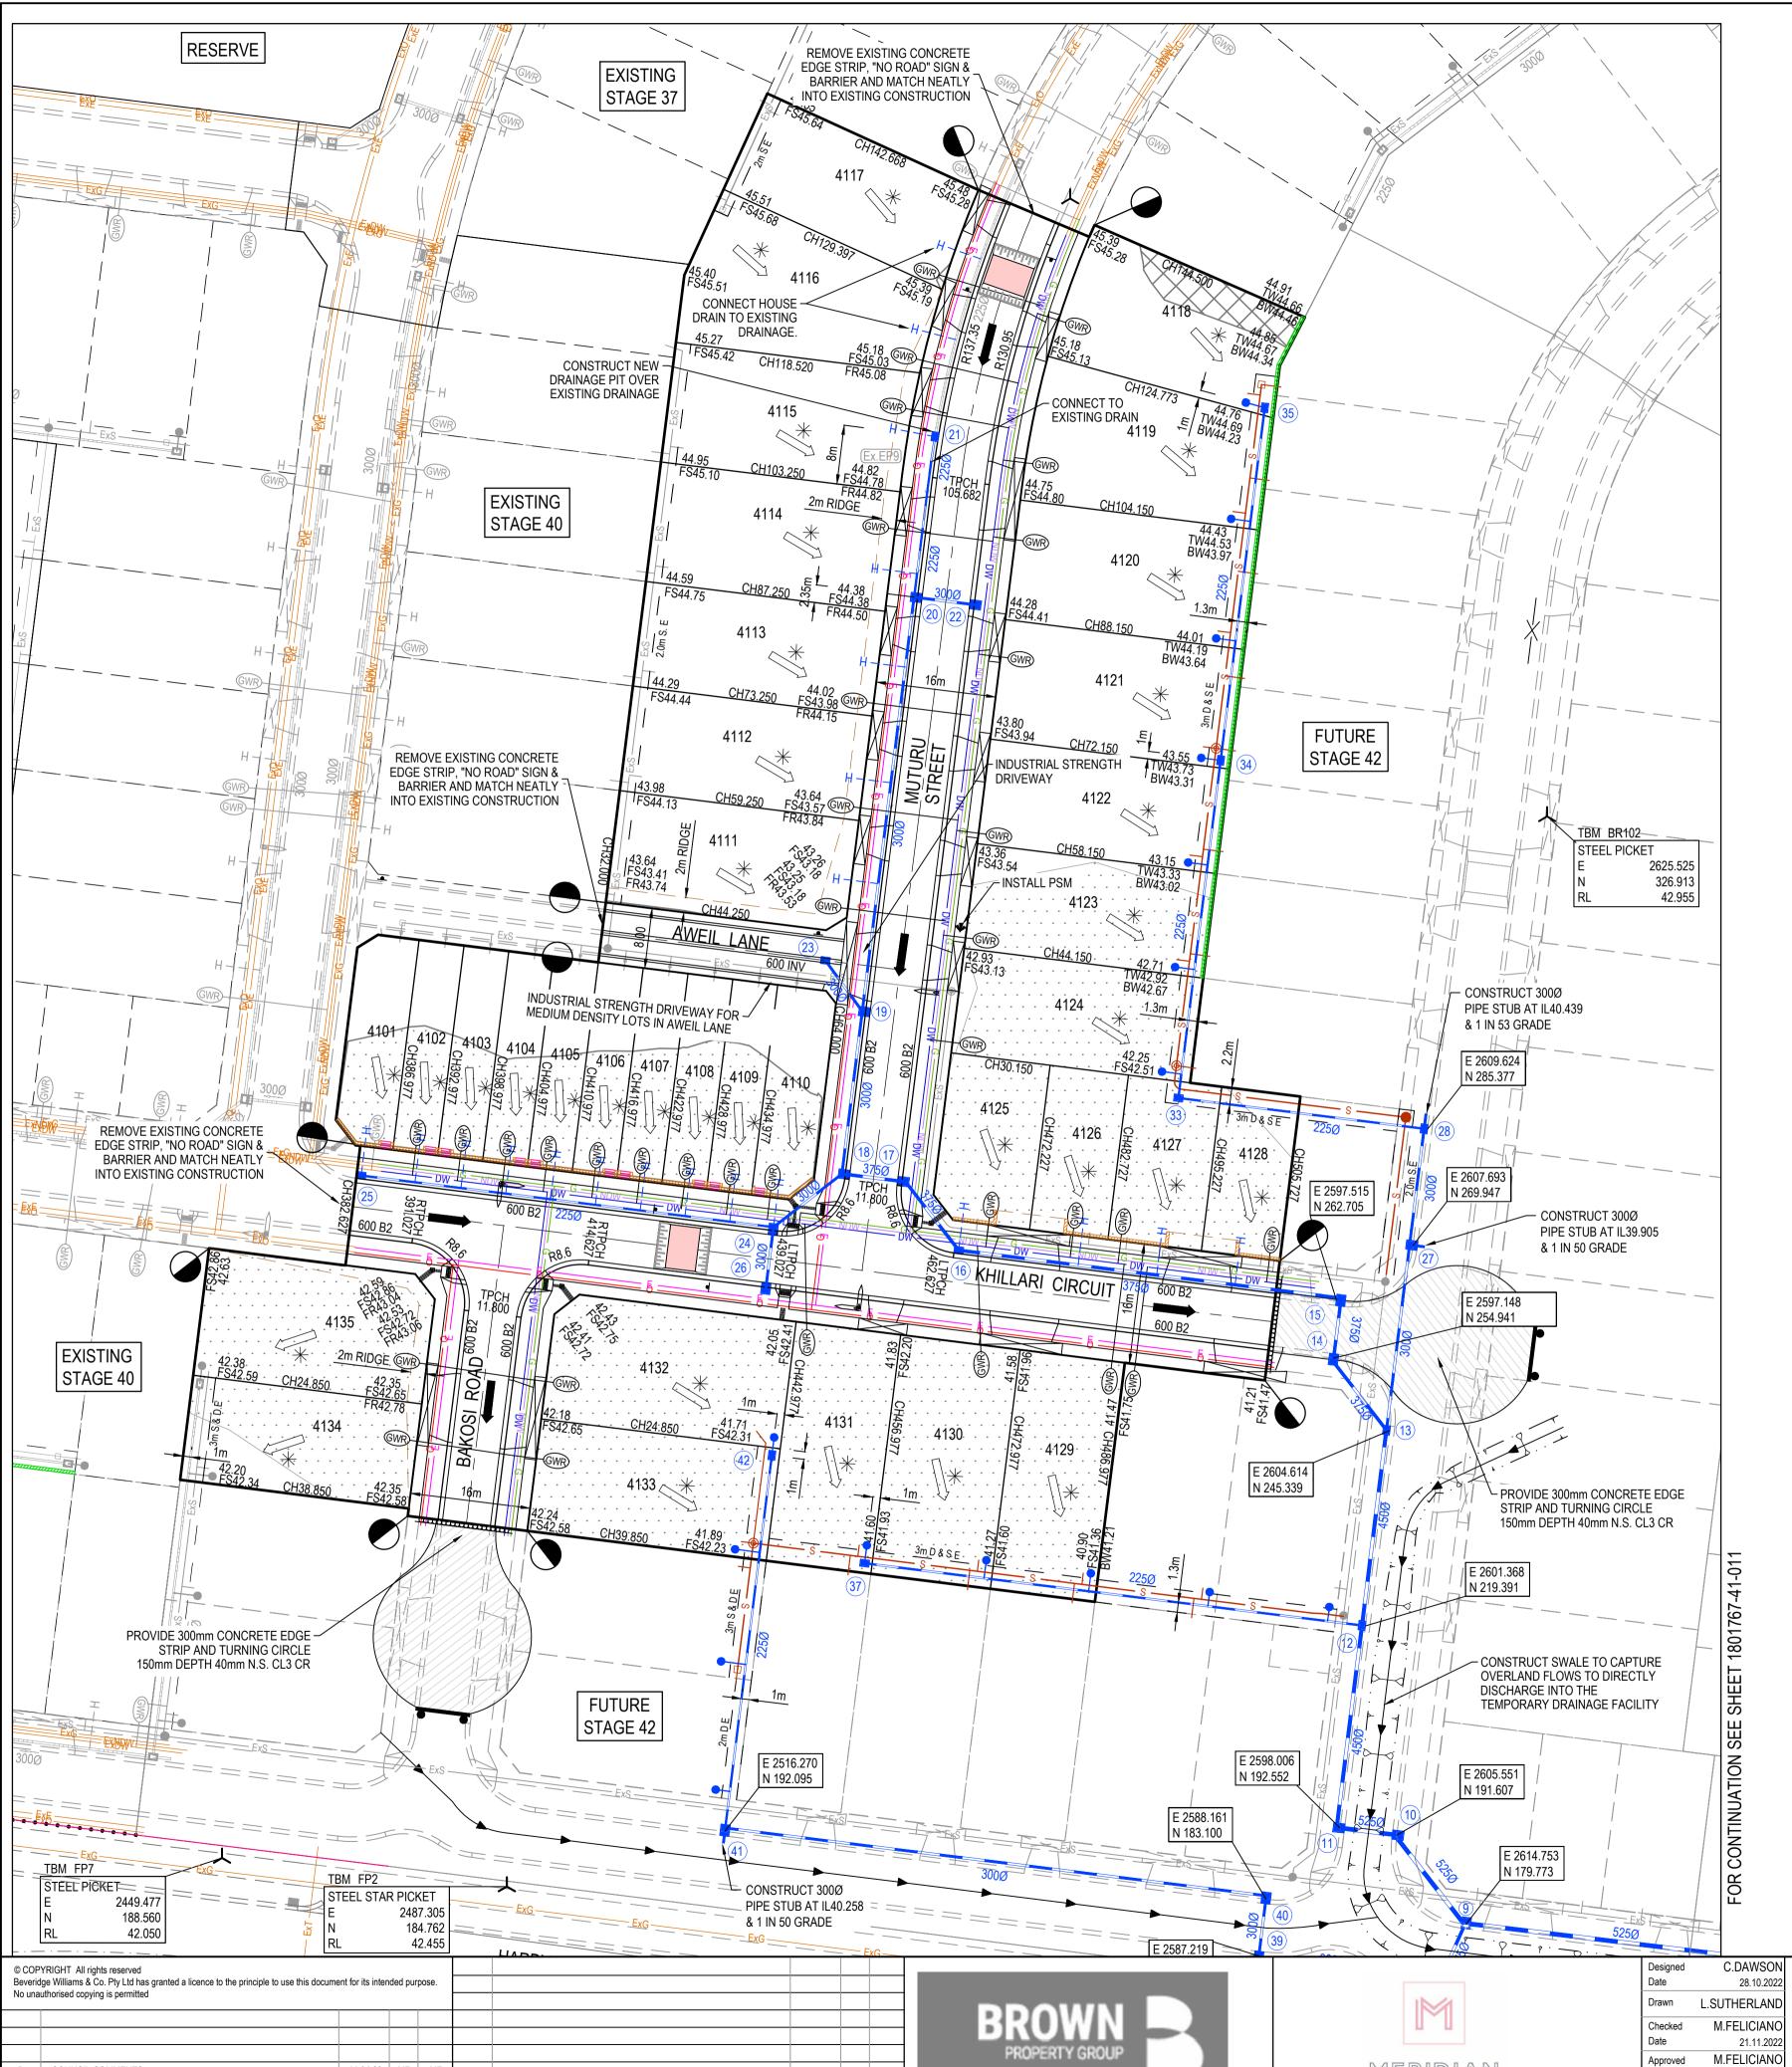
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Project Details	MERIDIAN CENTRAL ESTATE STAGE 41 CITY OF CASEY
Drawing Title	PAVEMENT MAKEUP & GENERAL DETA

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Project Ref	Stage No	Drawing No	Rev
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DATE DRN. APP


B COUNCIL COMMENTS

A ISSUED FOR CONSTRUCTION

11.04.23 | MF | MF

01.02.23 MF MF

DATE DRN. APP. REV

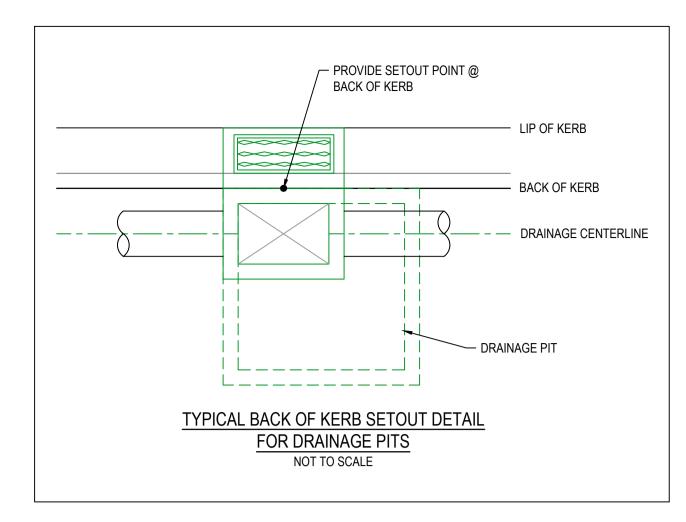


City of Casey

Approved By: Ange Dean Planning Ref: PA21-0174 File No: SEng00300/22 **Date:** 19/04/2023 **Council Drawing No.: R5956**

Approval subject to:

- A free draining out being available prior to Statement of Compliance.
- Drainage in future Stages 42, 43 & 45 may be amended
- A TMP approved prior to commencement of works.
- An EMP approved prior to commencement of works. - Relevant service authorities notification and approval

Signed:

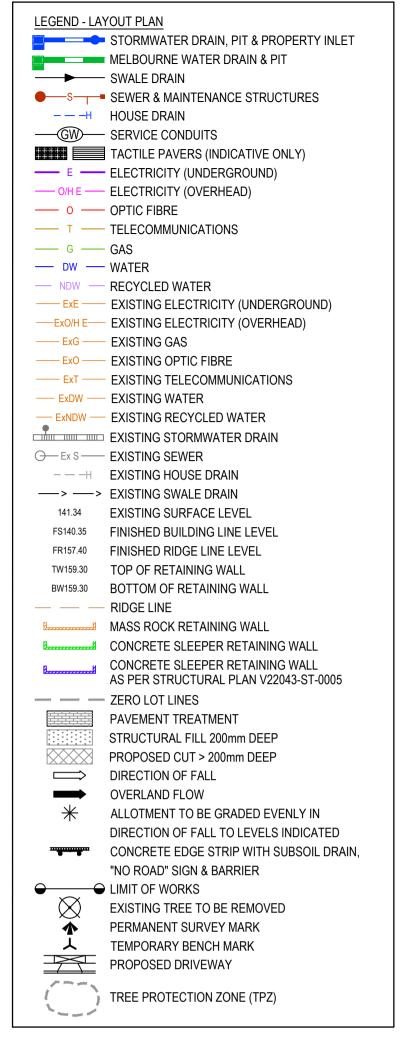

SERVICE OFFSET TARI F

OLIVIOL OT OLI TABLE												
	Gas		ND - Water		Water		Electricity		Telecommunication		Sewer	
Location	Side	Offset (m)	Side	Offset (m)	Side	Offset (m)	Side	Offset (m)	Side	Offset (m)	Side	Offset (m)
KHILLARI CIRCUIT	N	2.10	N	2.50	N	2.95	S	2.50	S	1.85	N	Ex1.0
MUTURU STREET	E	2.10	Е	2.50	Е	2.95	W	2.30	W	1.80	E	Ex4.0
BAKOSI ROAD	Е	2.10	Е	2.50	Е	2.95	W	2.50	W	1.85	-	-
AWEIL LANE	-	-	-	-	-	-	-	-	-	-	S	2.00

NOTE: STREET TREES ARE TO BE PLANTED IN THE CENTRE OF ALL NATURE STRIPS

ROAD LAYOUT TABLE

Dood Name	Reserve	ſ	Road Width (n	n)	Kerb	Туре	Verge W	/idth (m)
Road Name	Width (m)	Lip to Lip	Inv to Inv	Back to Back	Nth/West	Sth/East	Nth/West	Sth/East
KHILLARI CIRCUIT	16.00	6.40	7.30	7.60	600 B2	600 B2	4.50	4.20
MUTURU STREET	16.00	6.40	7.30	7.60	600 B2	600 B2	4.20	4.50
BAKOSI ROAD	16.00	6.40	7.30	7.60	600 B2	600 B2	4.20	4.50
AWEIL LANE	8.00	5.60	-	6.20	300 ES	300 ES	0.90	0.90

NOTE:

Approved

PE0005645

21.11.2022

PS906797B

Reg. No.

MERIDIAN

CENTRAL

THE AMOUNT OF STEPS SHOWN LEADING INTO THE ENTRY DOOR FOR LOTS 4101 - 4110 ARE INDICATIVE ONLY AND SHOWN TO THE PORCH. STEPS TO BE DETERMINED BY CONTRACTOR ON-SITE TO THE FINISHED FLOOR LEVEL OF THE HOUSES STEPS TO BE IN ACCORDANCE TO THE AS1657-2013 "FIXED

PLATFORMS, WALKWAYS, STAIRWAYS AND LADDERS"

SCALE 1:500 AT A1 SIZE

WARNING **BEWARE OF UNDERGROUND SERVICES** The locations of underground services are approximate only and their exact position should be proven on site. No guarantee is given that all existing services are shown. Locate all underground services before commencement of works

DIAL 1100 BEFORE YOU DIG www.1100.com.au

ISSUED FOR CONSTRUCTION




Project Details MERIDIAN CENTRAL ESTATE STAGE 41 CITY OF CASEY


Drawing LAYOUT PLAN (SHEET 1 OF 2)

Sheet 04 of 23 1:500 @ A1 Drawing No


Development and Infrastructure Consultants 1 Glenferrie Road ph: 03 9524 8888 Malvern VIC 3144 www.beveridgewilliams.com.au

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SWALE LONGITUDINAL SECTION NOT TO SCALE

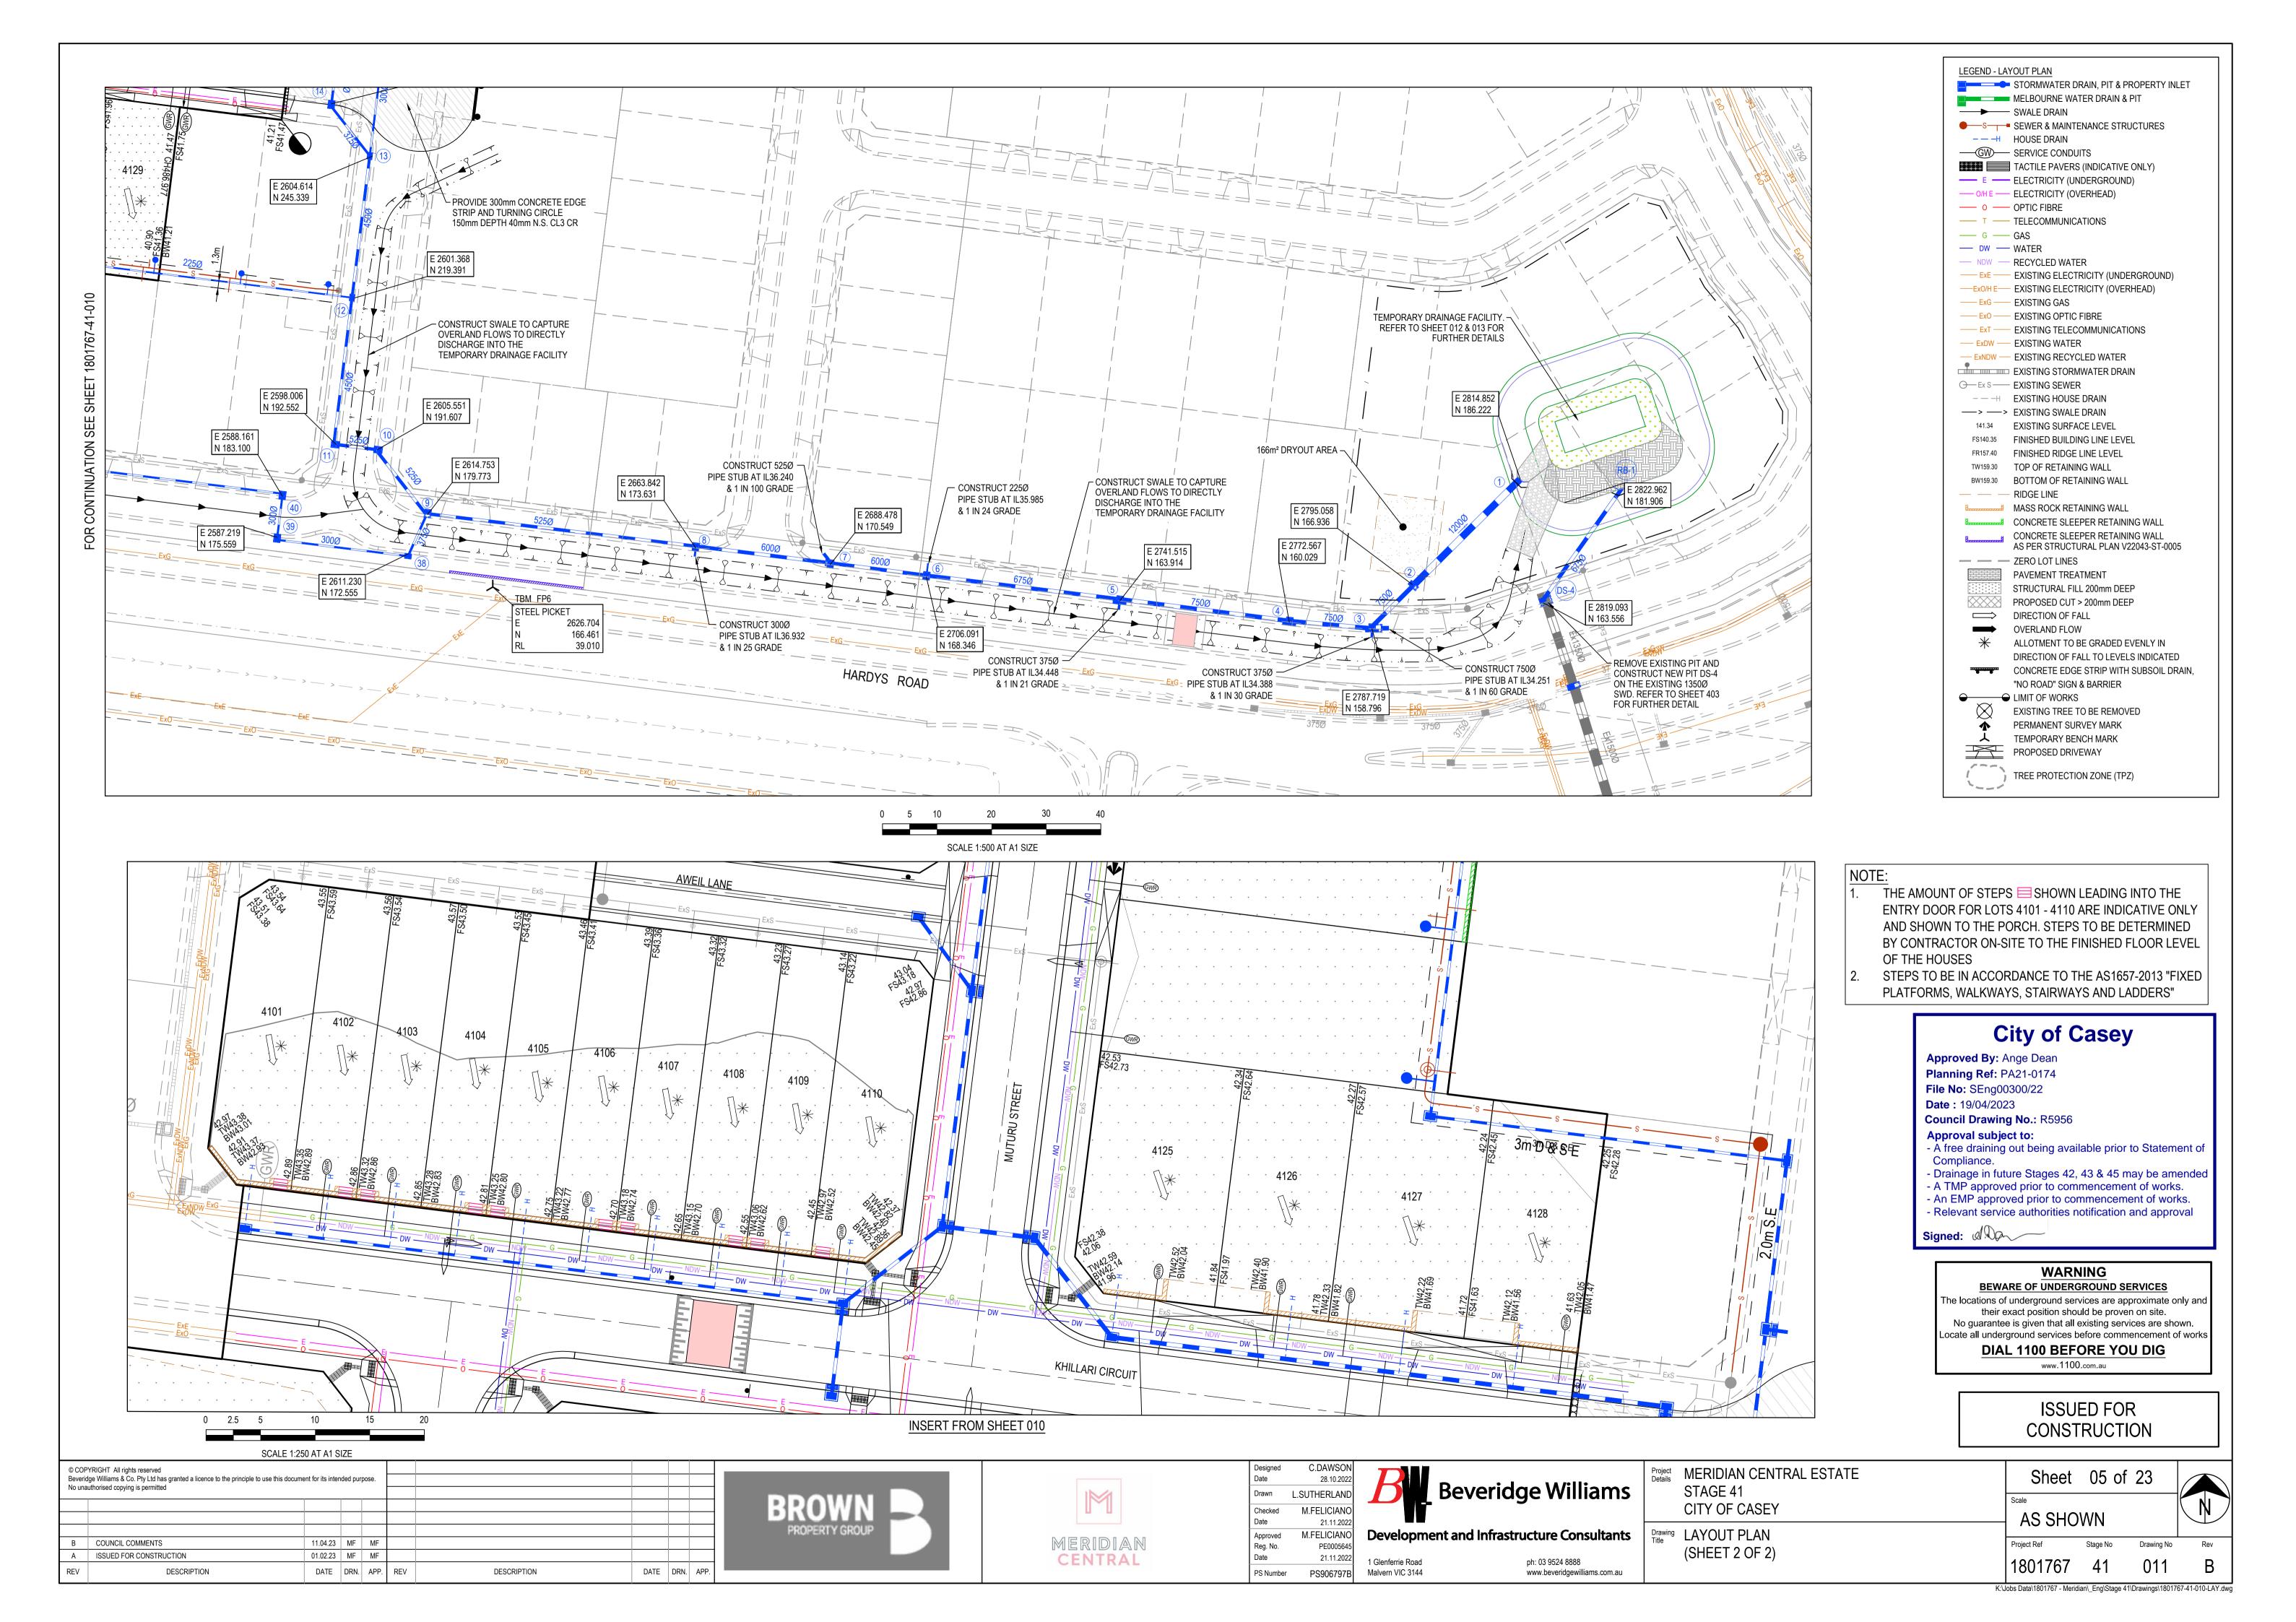

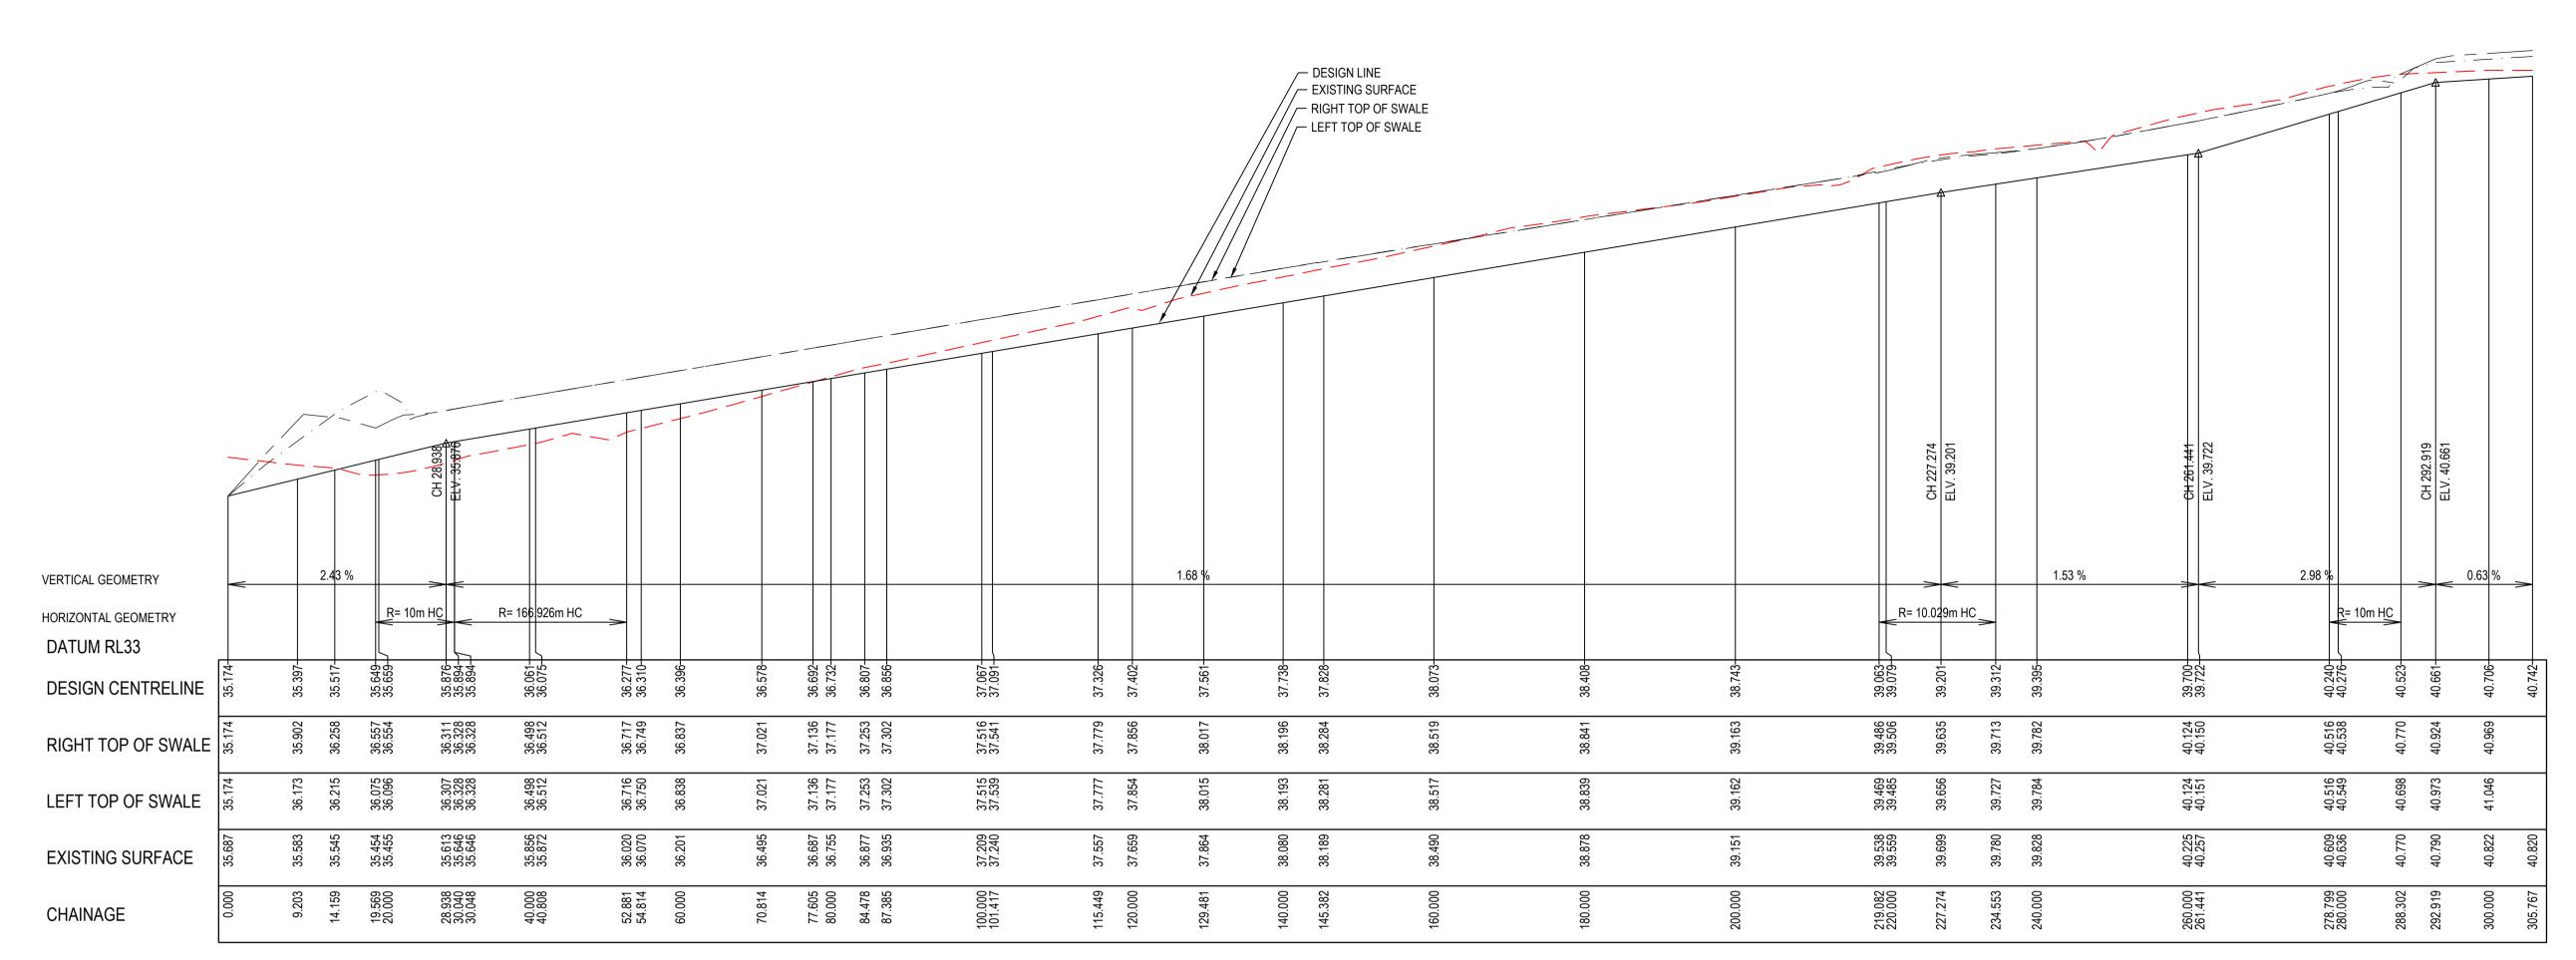City of Casey

Approved By: Ange Dean

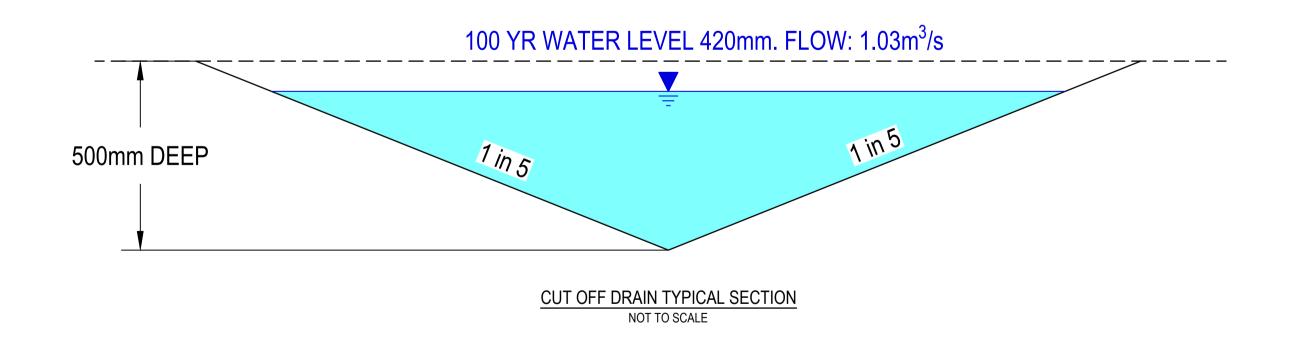Planning Ref: PA21-0174 File No: SEng00300/22

Date: 19/04/2023

Council Drawing No.: R5956

Approval subject to:

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REV	DESCRIPTION	DATE	DRN.	APP.	REV	DESCRIPTION	DATE	DRN.	APP.	
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Approved Reg. No. Date

PS906797B

Malvern VIC 3144




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Project Details	MERIDIAN CENTRAL ESTATE STAGE 41 CITY OF CASEY
Drawing	SWALE DRAIN


MERIDIAN CENTRAL ESTATE STAGE 41	Sheet 06 of 23	/
CITY OF CASEY	AS SHOWN	
9 SWALE DRAIN		
LONGITUDINAL SECTION	Project Ref Stage No Drawing No	
& TYPICAL CROSS SECTION	1801767 41 012	


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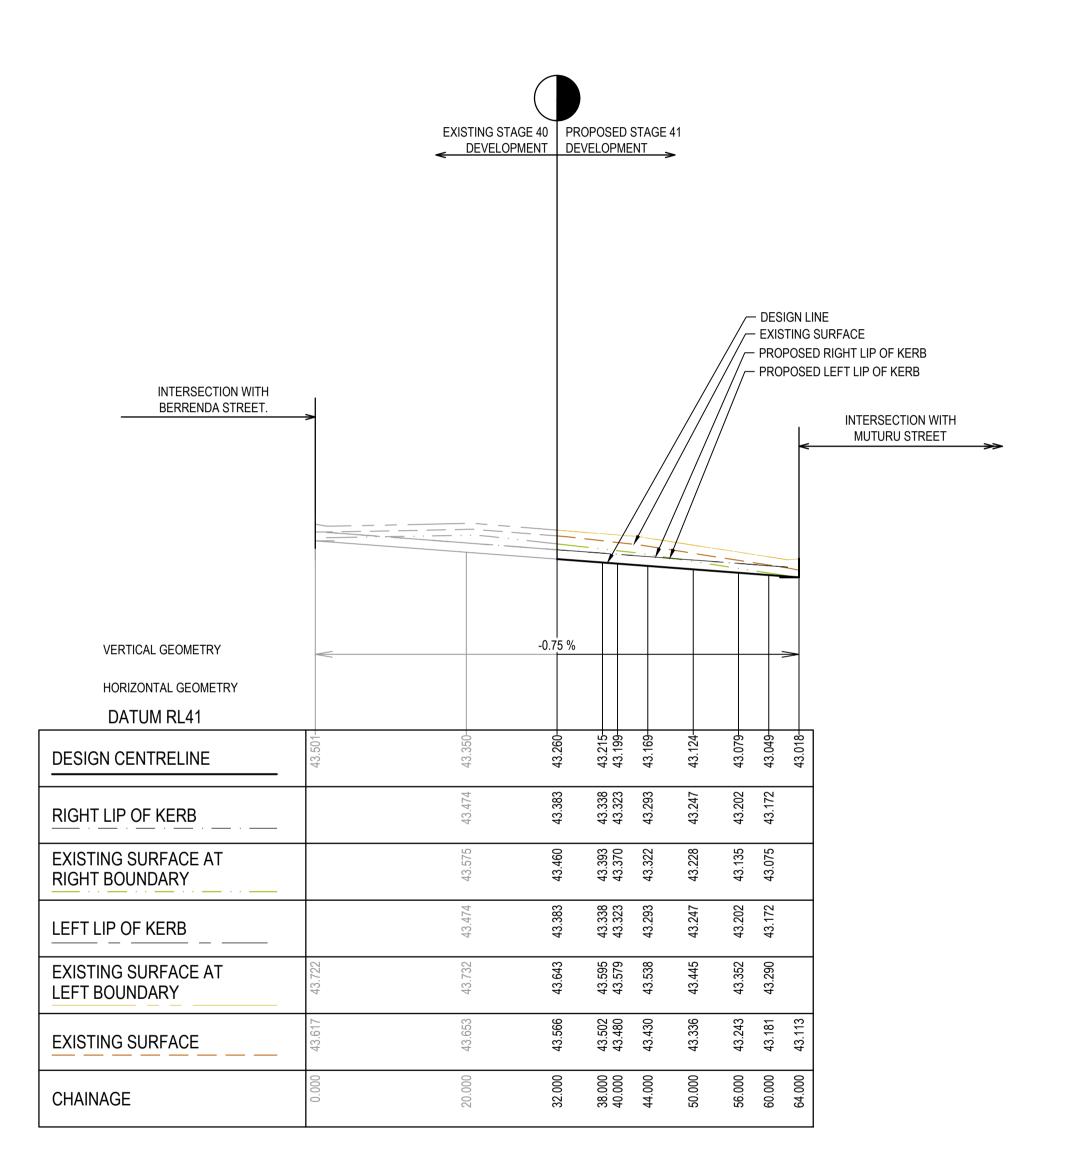
Drawing No




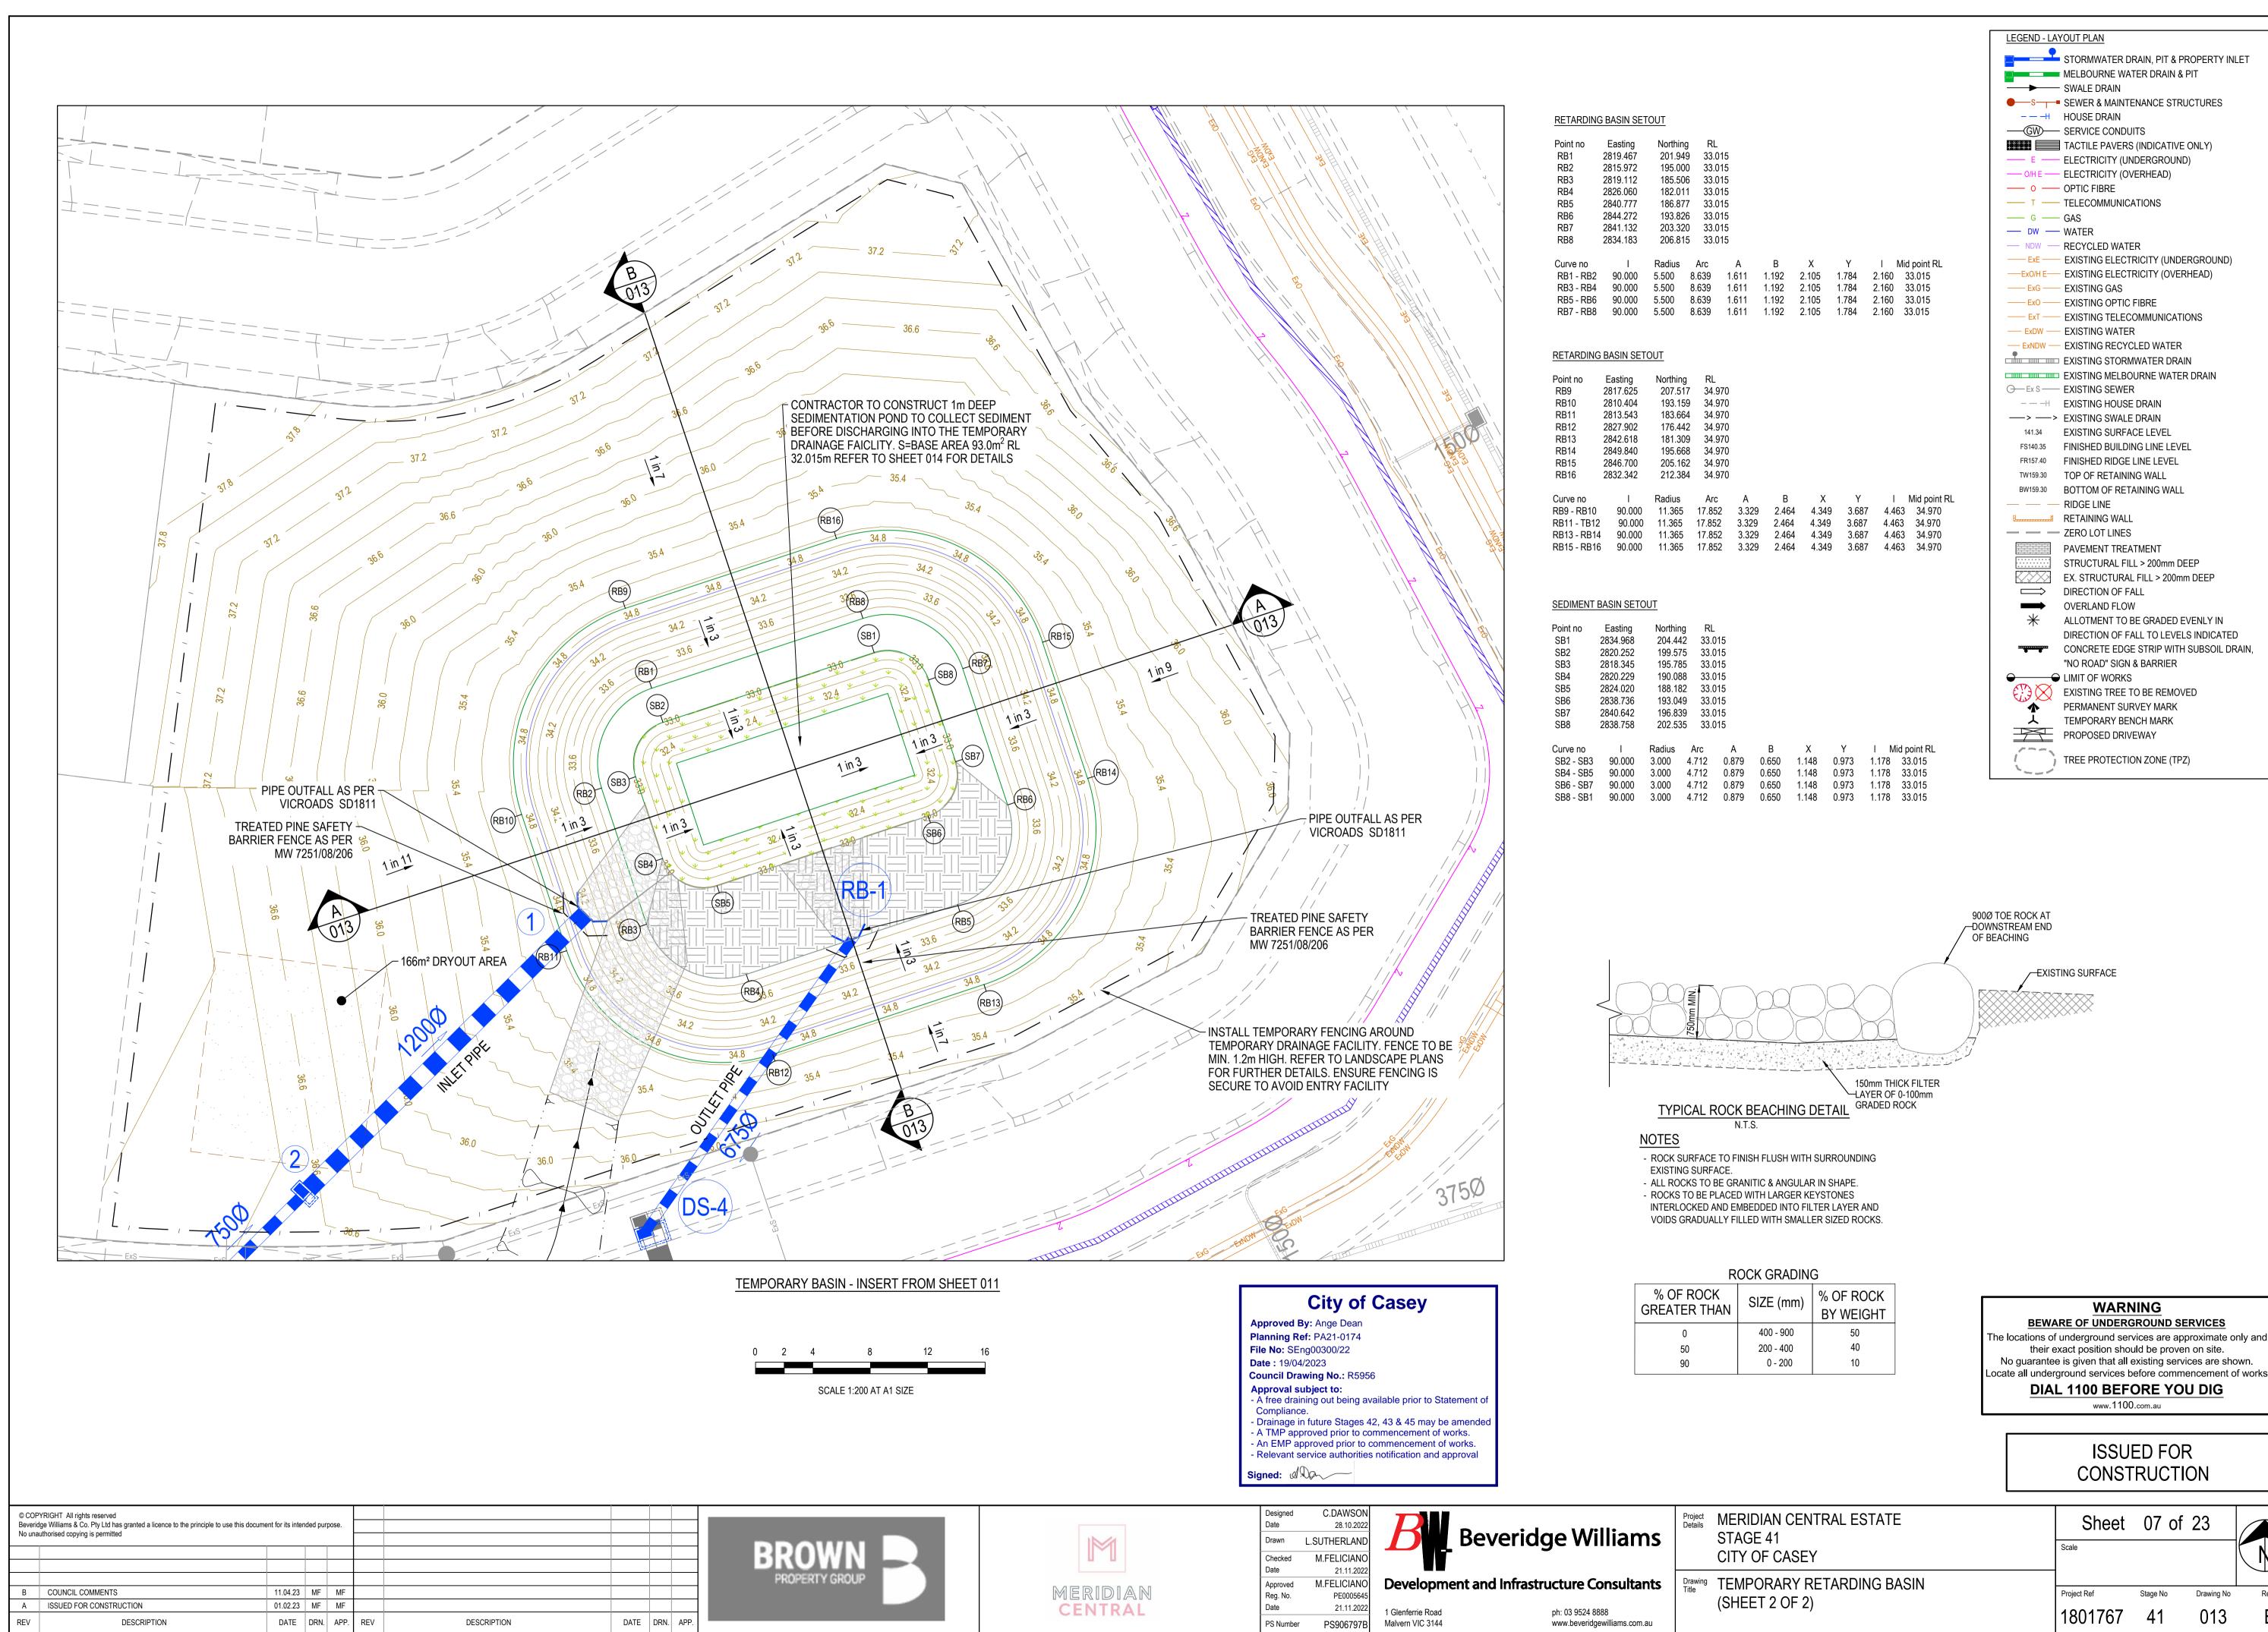

Approved By: Ange Dean Planning Ref: PA21-0174

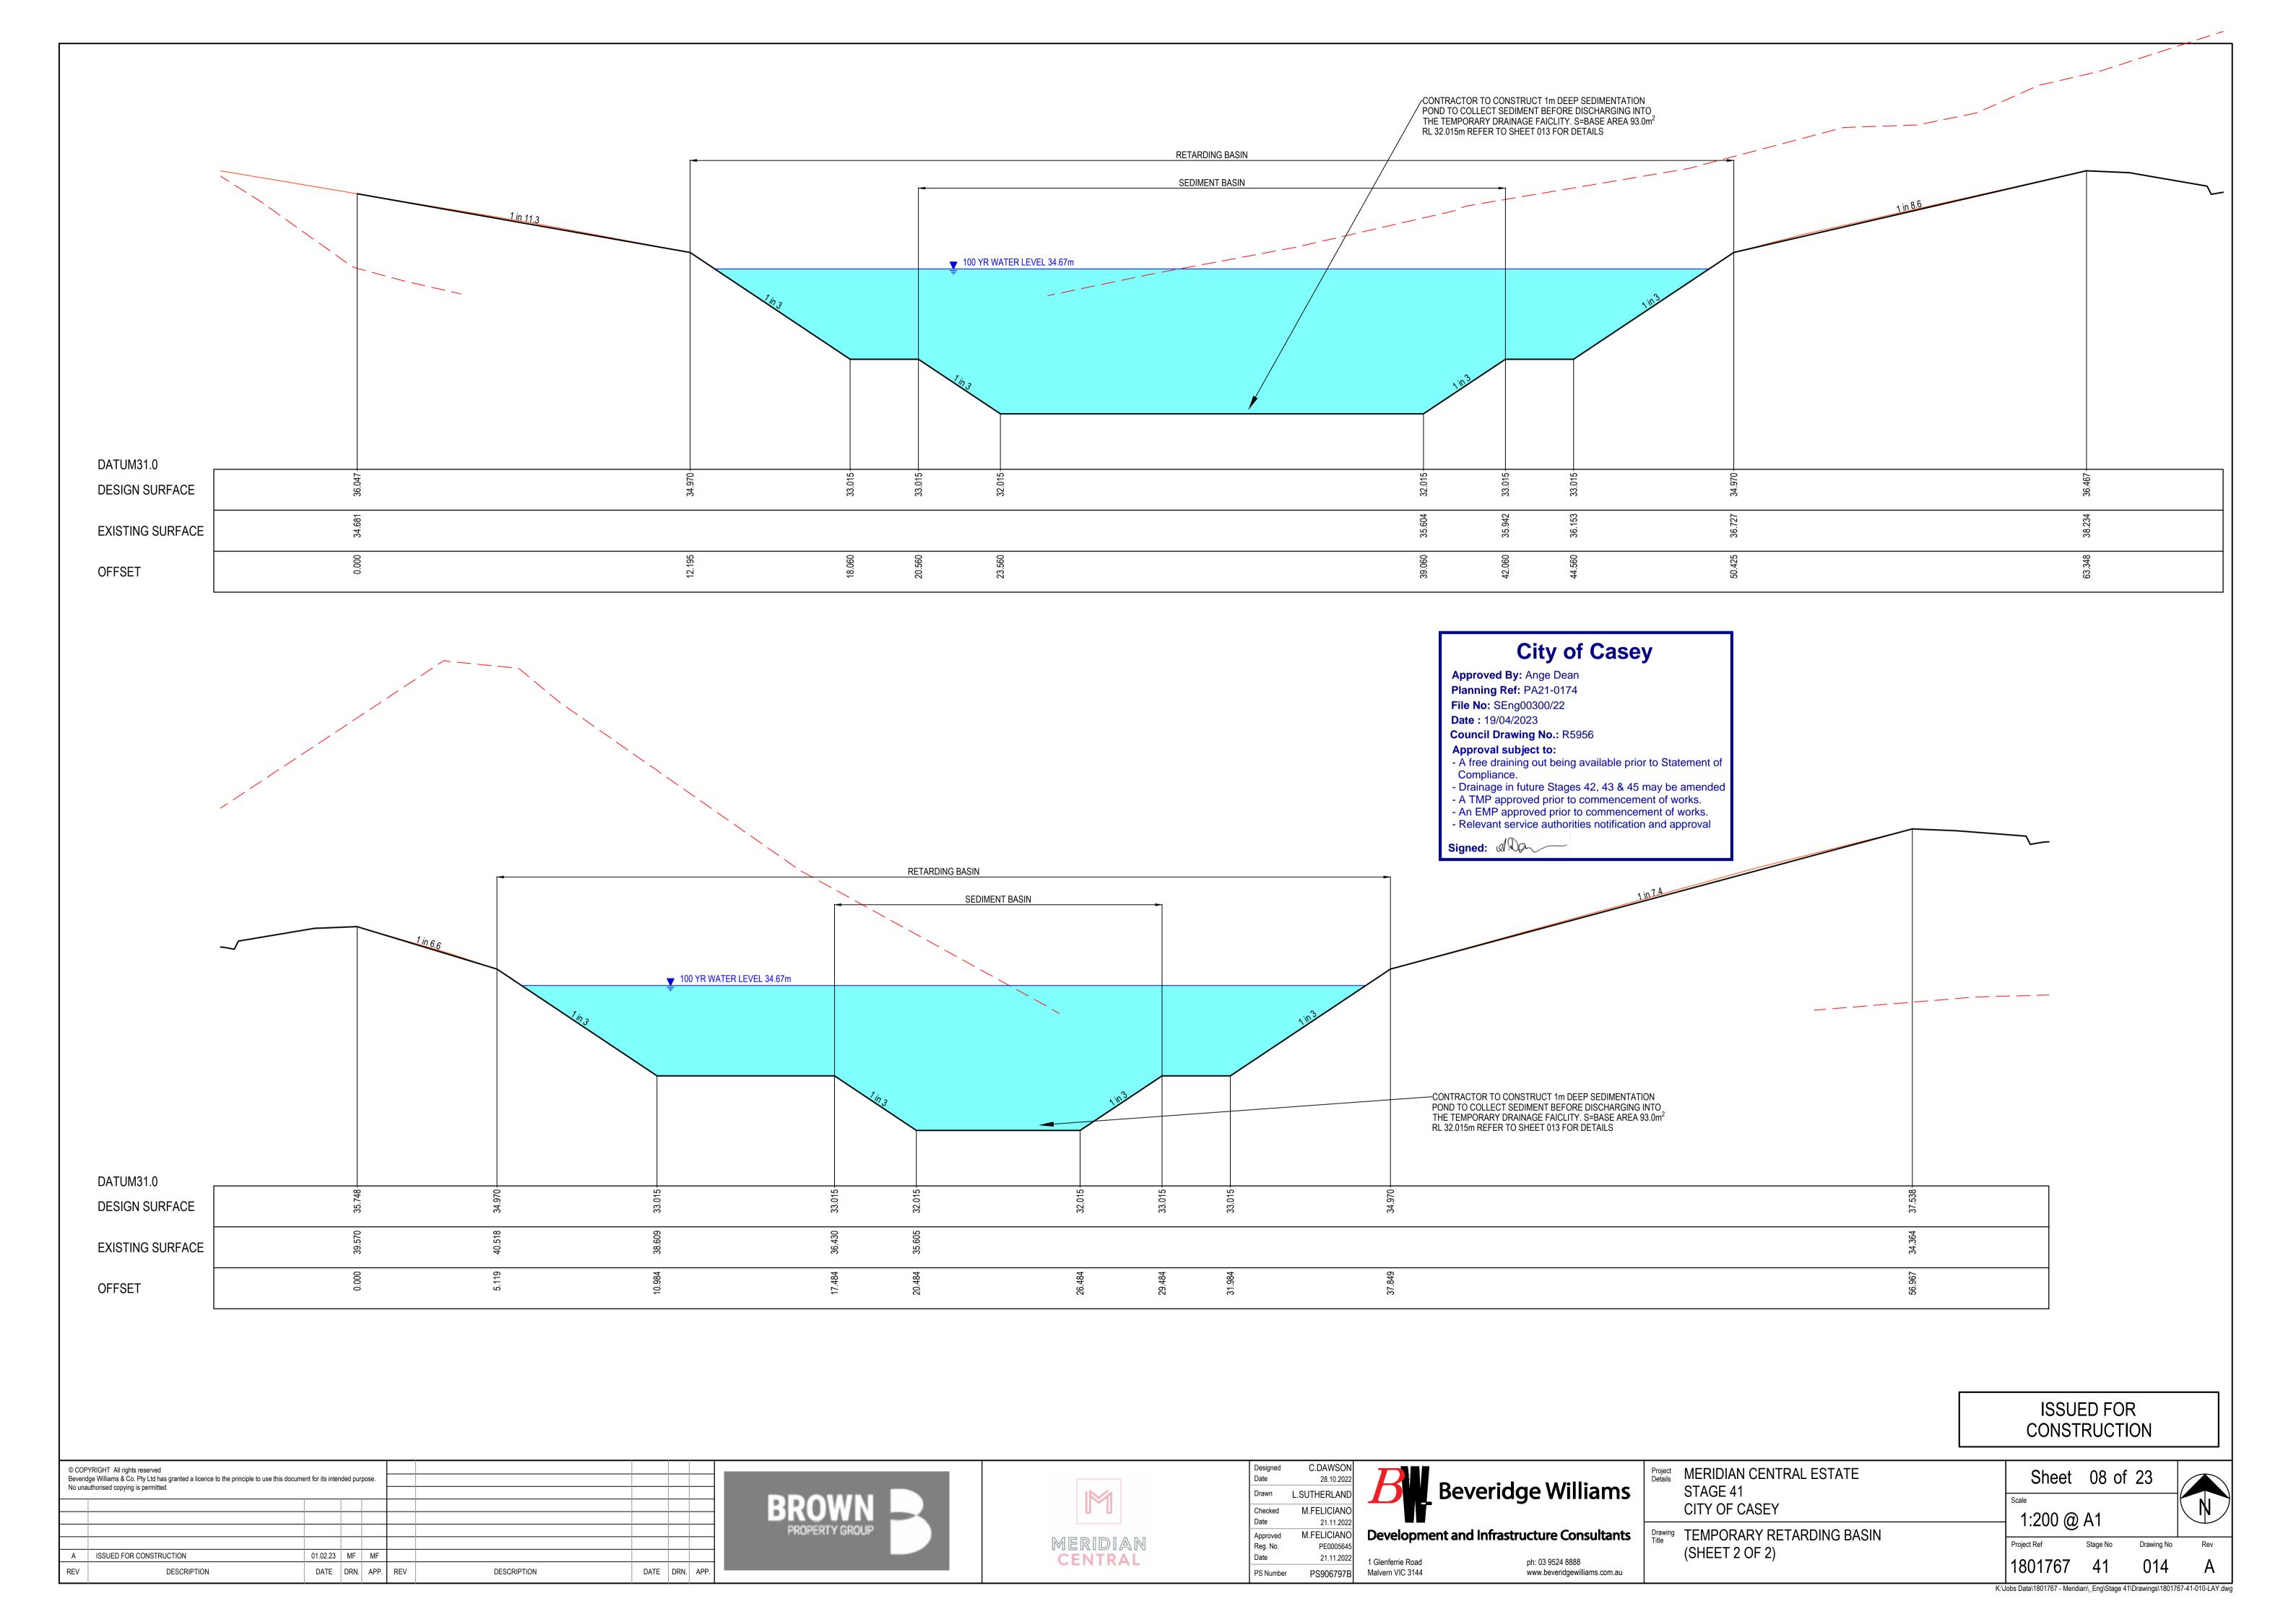File No: SEng00300/22

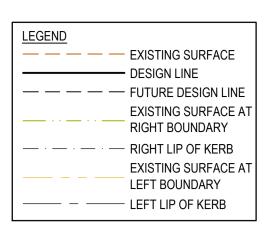

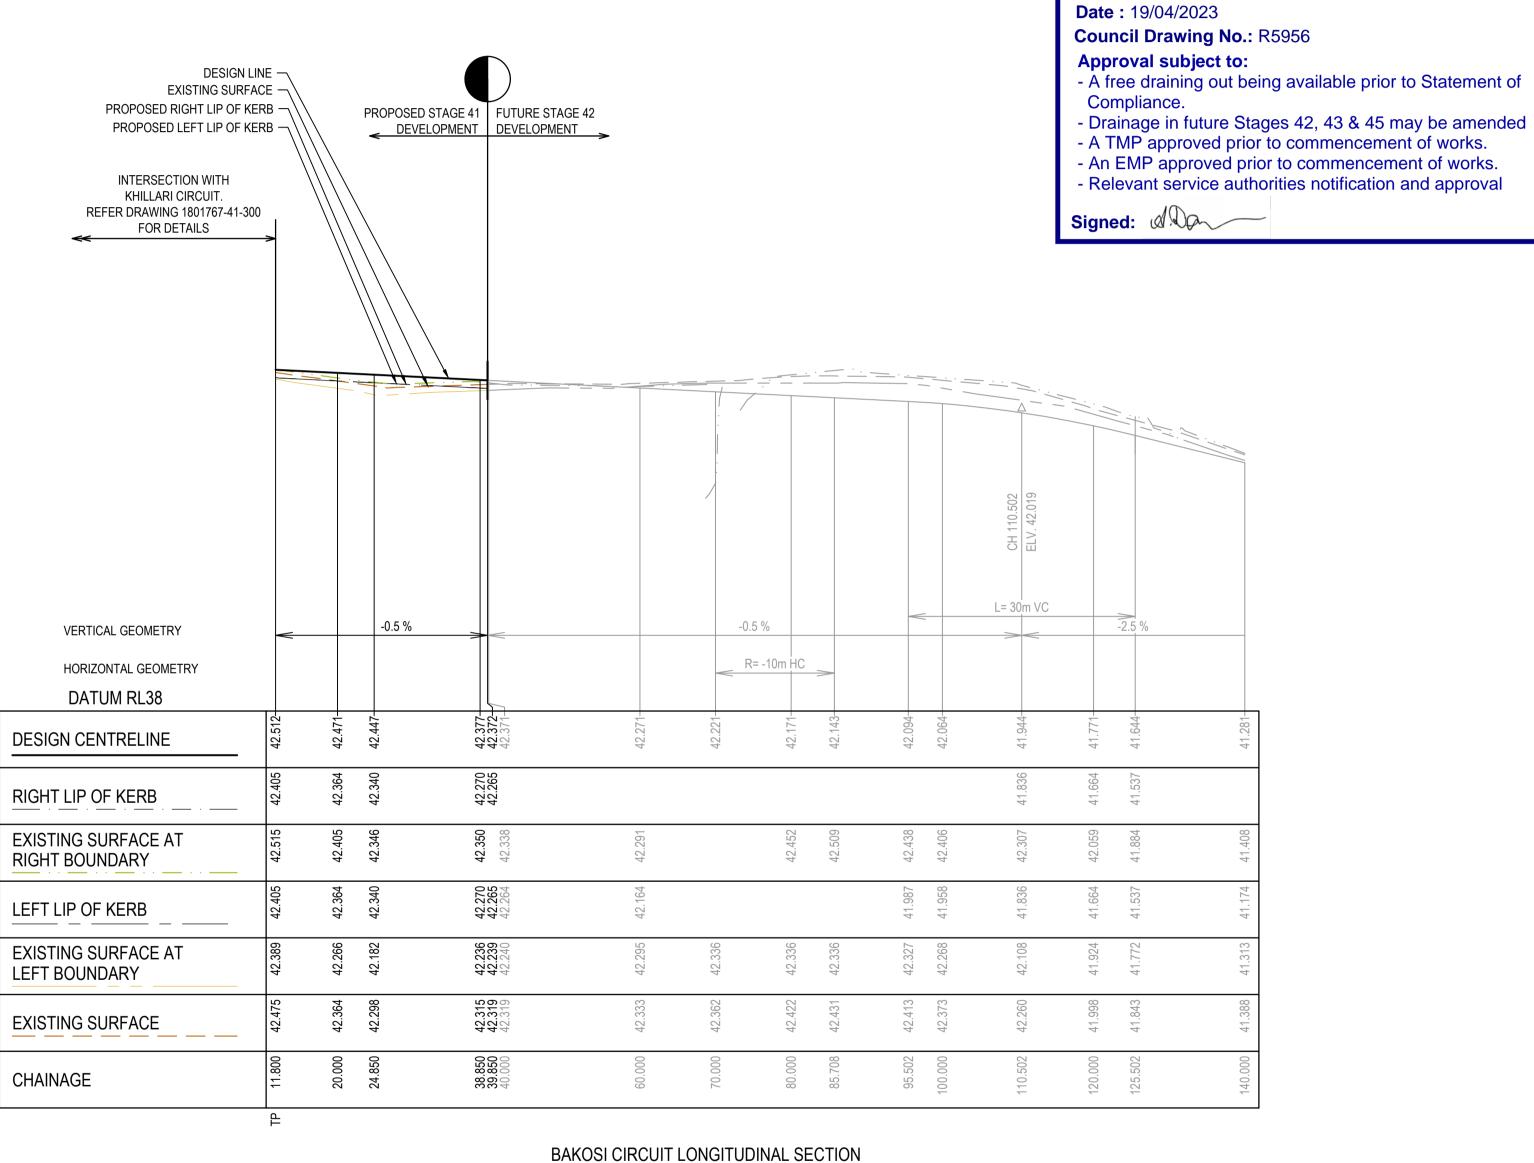

AWEIL LANE LONGITUDINAL SECTION

HORIZ 1:500 VERT 1:50 0 0.5 1 SCALE AT A1 SIZE

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	D Beve	L.SUTHERLAND	Beverio
Ì		M.FELICIANO	
ļ		21.11.2022	
I	Development and In	M.FELICIANO	nt and Infras
I	•	PE0005645	
ļ	1 Glenferrie Road	21.11.2022	
ı			

Malvern VIC 3144

Checked Date

PS Number PS906797B

Beveridge Williams
Development and Infrastructure Consultants


ph: 03 9524 8888


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	l				
Project Details	MERIDIAN CENTRAL ESTATE STAGE 41	Sheet	09 of	23	
	CITY OF CASEY	Scale			
	CITTOF CASET	1:500 H	1:50 V	@ A1	
Drawing	ROAD LONGITUDINAL SECTIONS			<u> </u>	
Title	AWEIL LANE & BAKOSI CIRCUIT	Project Ref	Stage No	Drawing No	
	AWEIL LANE & DAROSI CIRCUIT	1801767	41	100	
		1001707	71	100	

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Approved By: Ange Dean Planning Ref: PA21-0174 File No: SEng00300/22

Date: 19/04/2023 **Council Drawing No.:** R5956

Approval subject to:

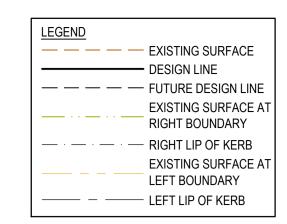- A free draining out being available prior to Statement of

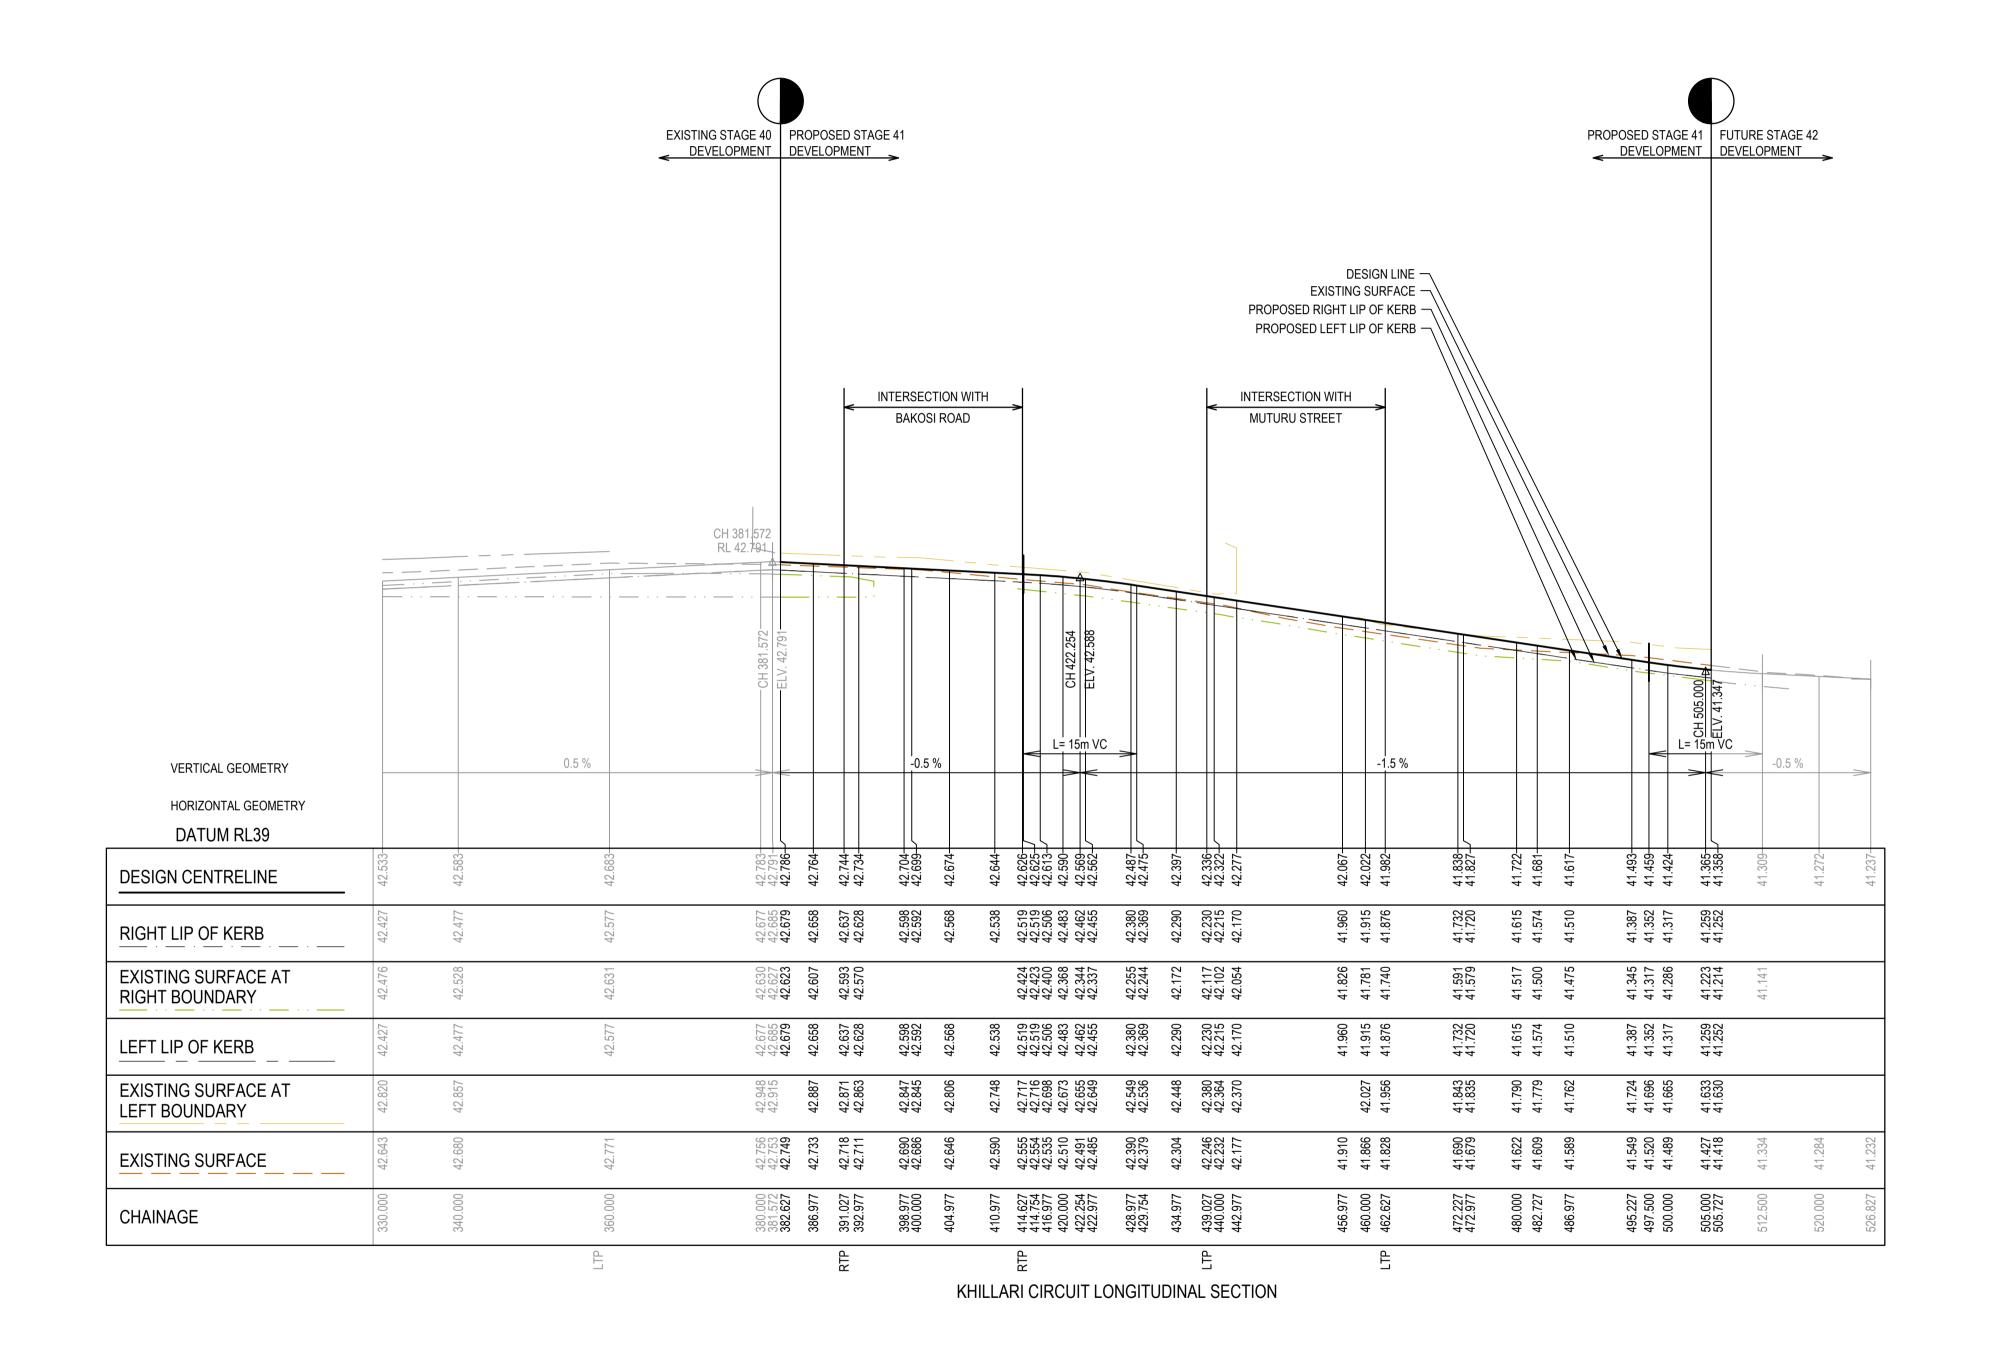- Compliance.
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- Relevant service authorities notification and approval

Signed: Do

HORIZ 1:500 0 5 10 20 30 SCALE AT A1 SIZE

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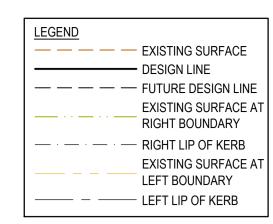
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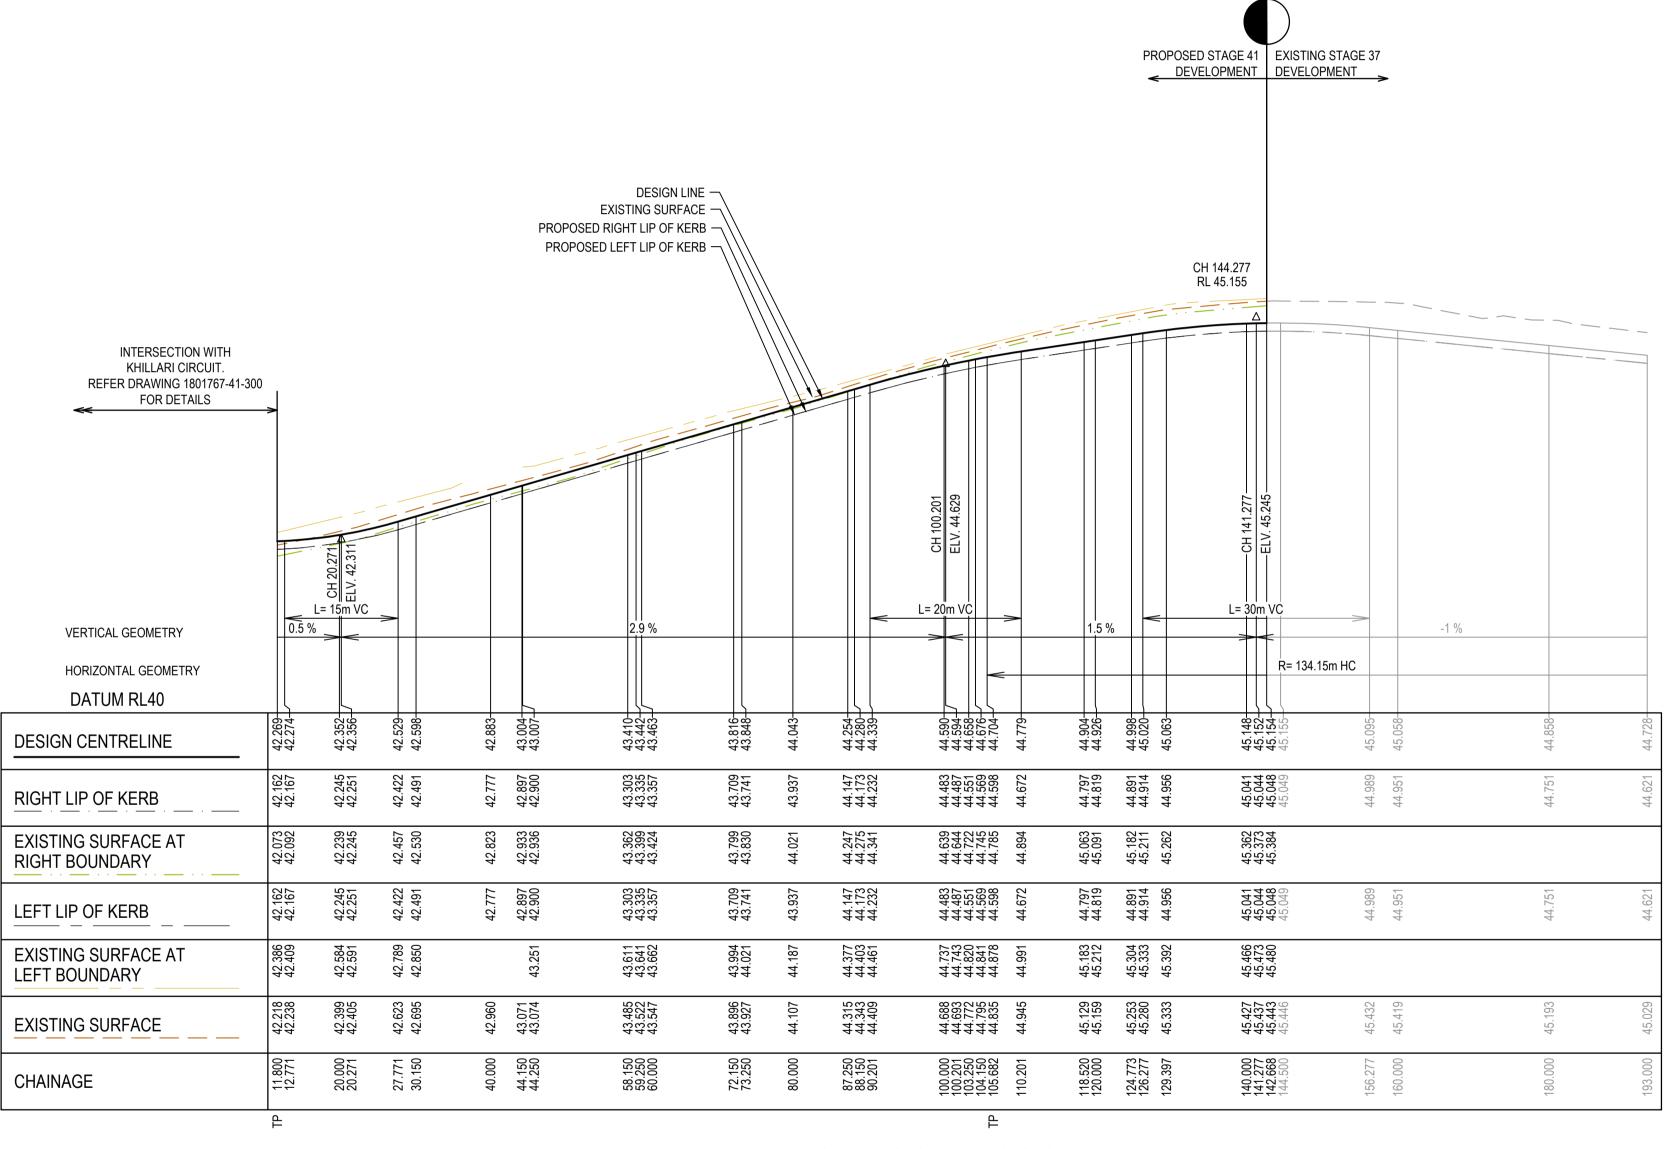


roject etails	MERIDIAN CENTRAL ESTATE STAGE 41	Sheet	10 of	23
	CITY OF CASEY	1:500 H	1·50 \/ <i>(</i>	ന ∆1
rawing	ROAD LONGITUDINAL SECTIONS	1.00011	1.00 V (ω $/$ (1)
tle	KHILLARI CIRCUIT	Project Ref	Stage No	Drawing No
	NHILLANI CINCUII	4004707	4.4	404

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Drawing No





MUTURU STREET LONGITUDINAL SECTION

City of Casey

Approved By: Ange Dean

Planning Ref: PA21-0174 File No: SEng00300/22

Date: 19/04/2023

Council Drawing No.: R5956

Approval subject to: - A free draining out being available prior to Statement of

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Signed:

SCALE AT A1 SIZE

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	M.FELICIANO
	21.11.2022
Development	M.FELICIANO
	PE0005645
1 Glenferrie Road	21.11.2022

Malvern VIC 3144

Checked Date

Approved

Reg. No.

PS Number PS906797B



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	Project Details	MERIDIAN CENTRAL ESTATE STAGE 41 CITY OF CASEY
;	Drawing Title	ROAD LONGITUDINAL SECTIONS MUTURU STREET

	Sheet	11 of	23	
	Scale	4.50.14	0.44	
NS	1:500 H	1:50 V	@ A1	
INO	Project Ref	Stage No	Drawing No	
	1801767	41	102	

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Rev

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CONSTRUCTION


Approved By: Ange Dean Planning Ref: PA21-0174

File No: SEng00300/22 Date: 19/04/2023 **Council Drawing No.:** R5956


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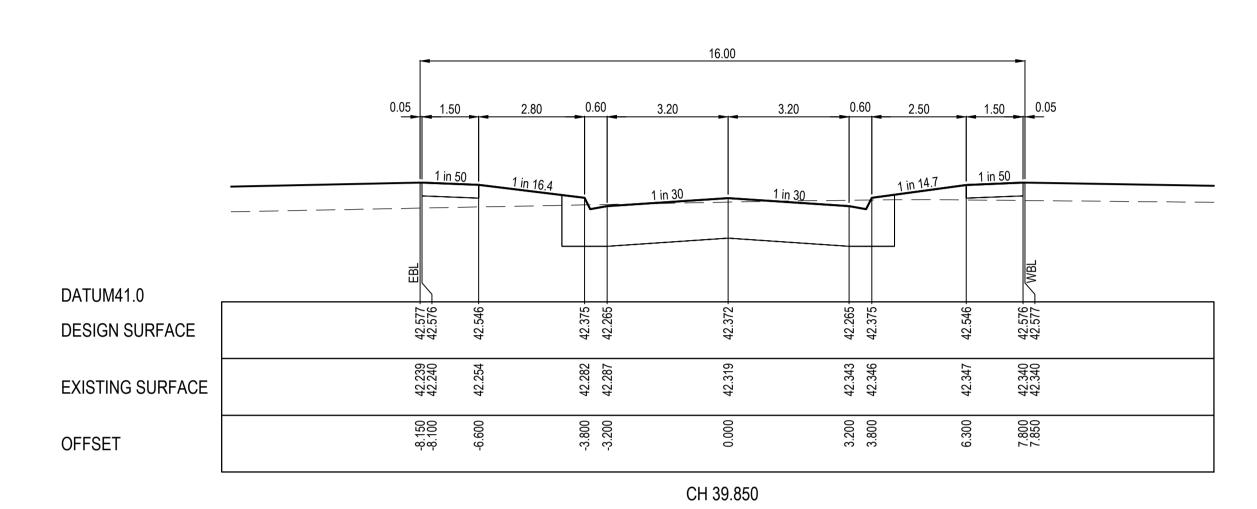
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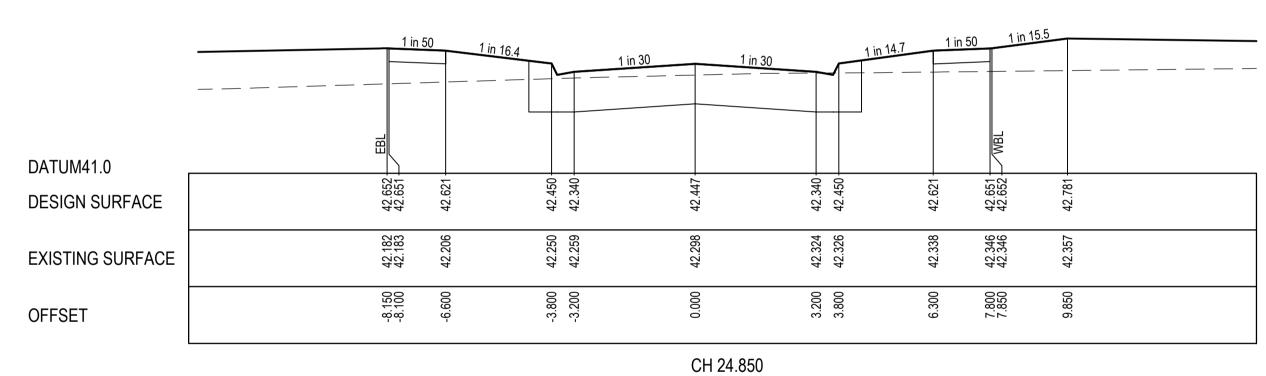
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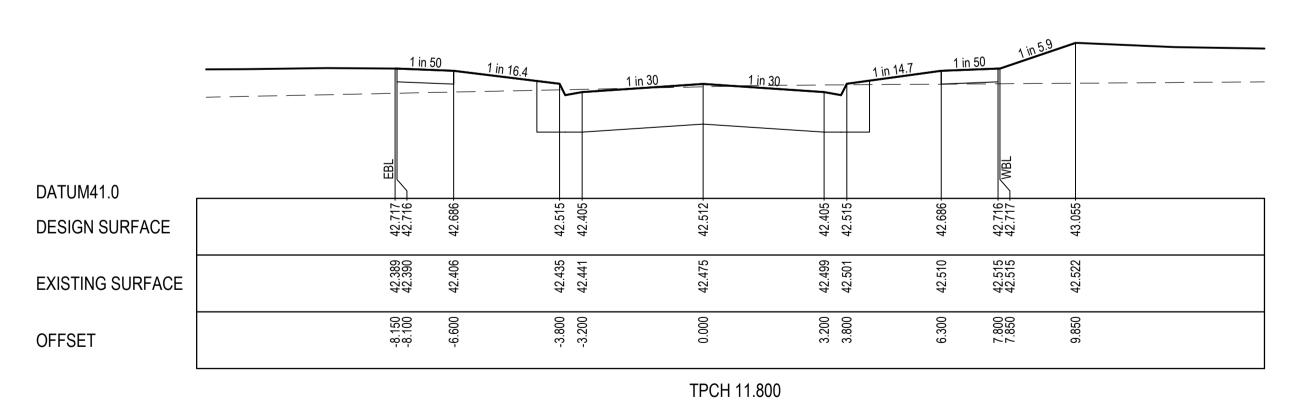


STRUCTURAL FILL REQUIRED UNDER PAVEMENT AND FOOTPATHS WHERE CONSTRUCTED ABOVE NATURAL SURFACE. REFER GEOTECH REPORT FOR SPECIFICATION



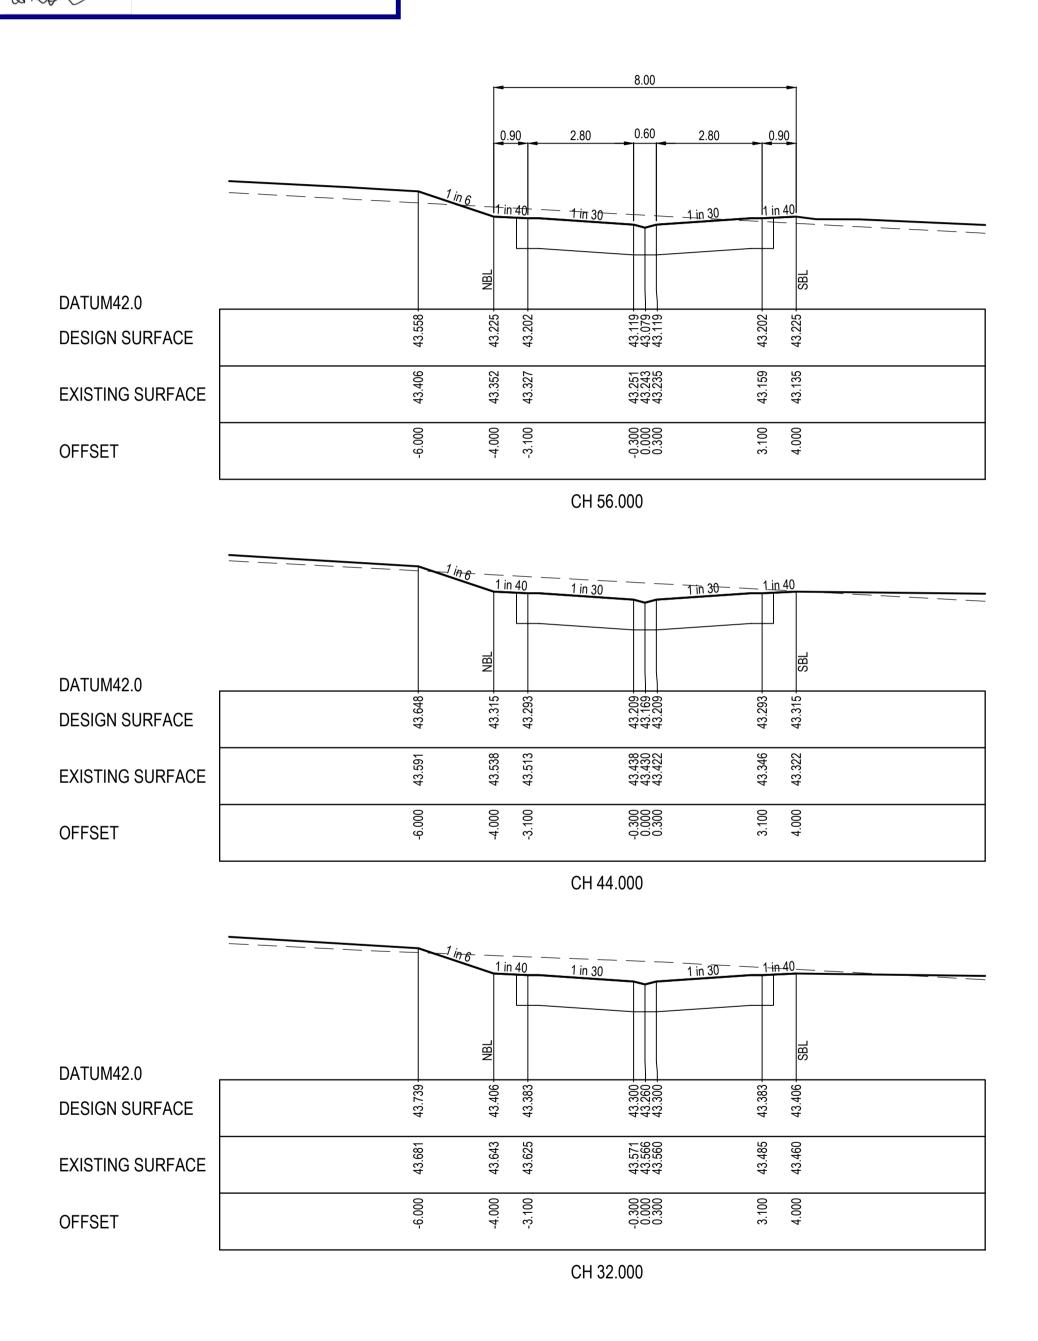



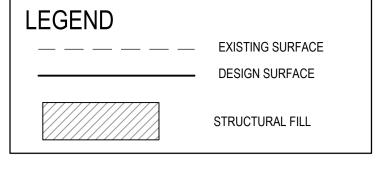


AWEIL LANE CROSS SECTIONS

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Malvern VIC 3144

PS906797B

Approved

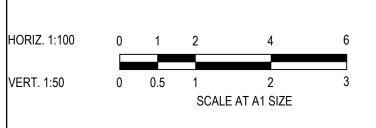

ph: 03 9524 8888

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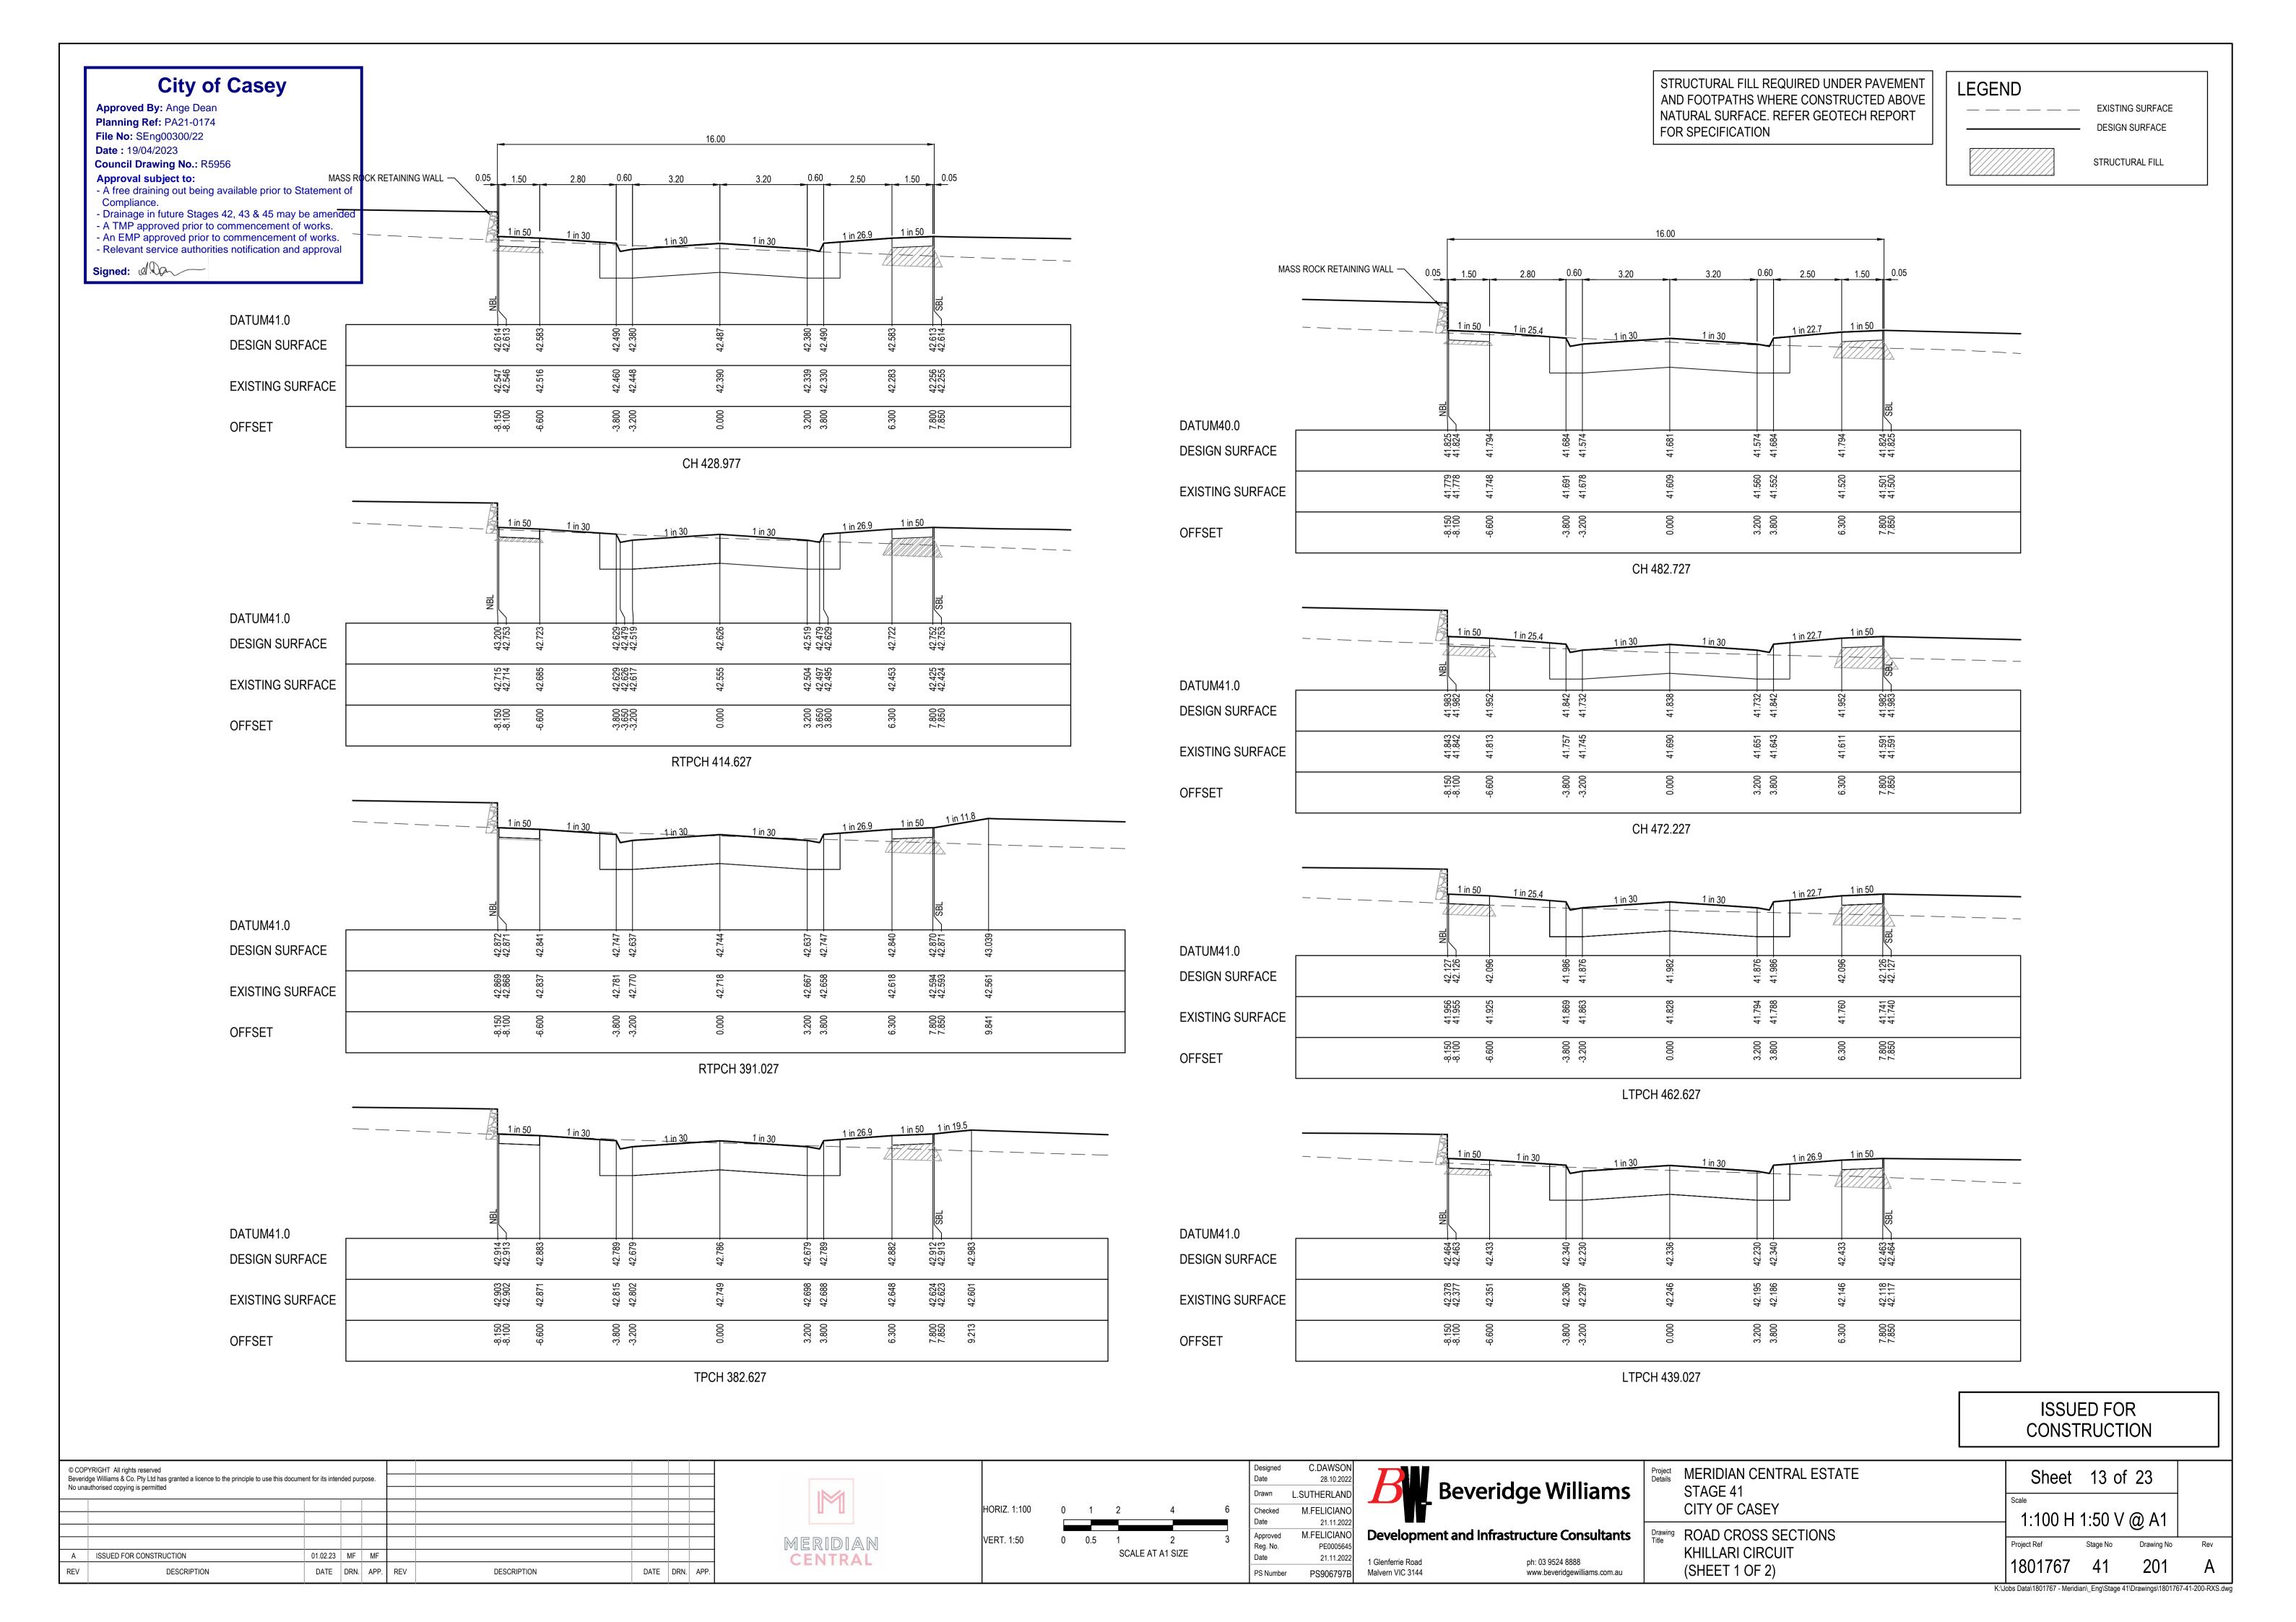
Project Details	MERIDIAN CENTRAL ESTATE STAGE 41 CITY OF CASEY
Drawing	ROAD CROSS SECTIONS

AWEIL LANE & BAKOSI CIRCUIT


BAKOSI STREET CROSS SECTIONS


Sheet 12 of 23 1:100 H 1:50 V @ A1 Drawing No

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STRUCTURAL FILL REQUIRED UNDER PAVEMENT AND FOOTPATHS WHERE CONSTRUCTED ABOVE NATURAL SURFACE. REFER GEOTECH REPORT FOR SPECIFICATION



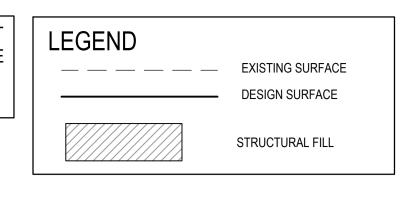

DATUM40.0 41.637 -41.638 -41.497 41.638 41.637 **DESIGN SURFACE** 41.724 41.723 41.631 41.347 41.345 **EXISTING SURFACE** -8.150 -8.100 7.800 7.850 OFFSET

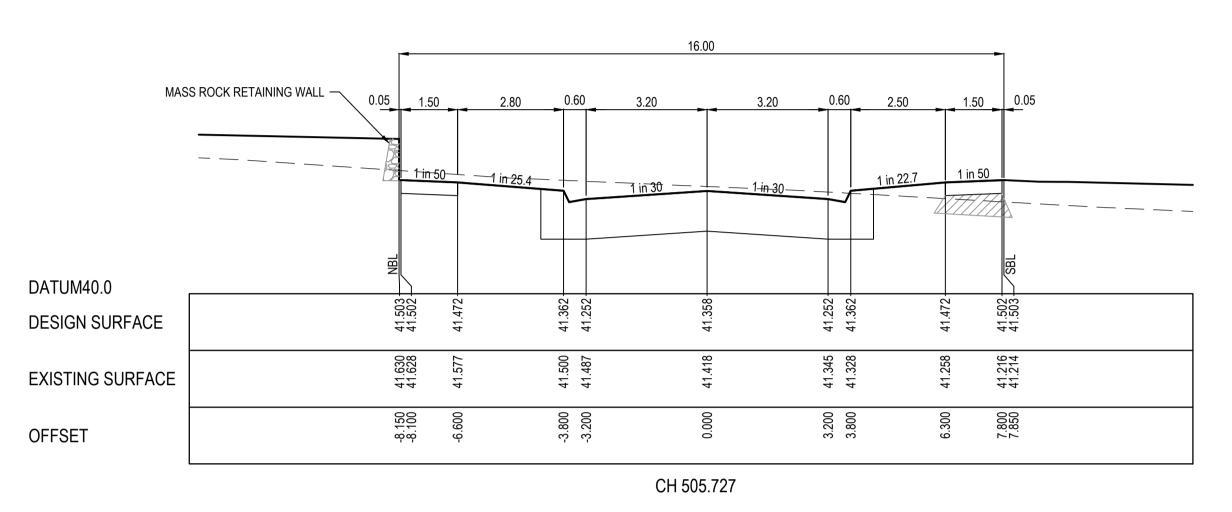CH 495.227

City of Casey

Approved By: Ange Dean Planning Ref: PA21-0174 File No: SEng00300/22 Date: 19/04/2023

Council Drawing No.: R5956

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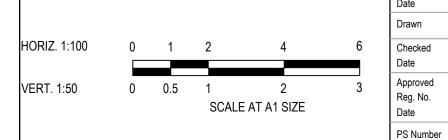
Signed:

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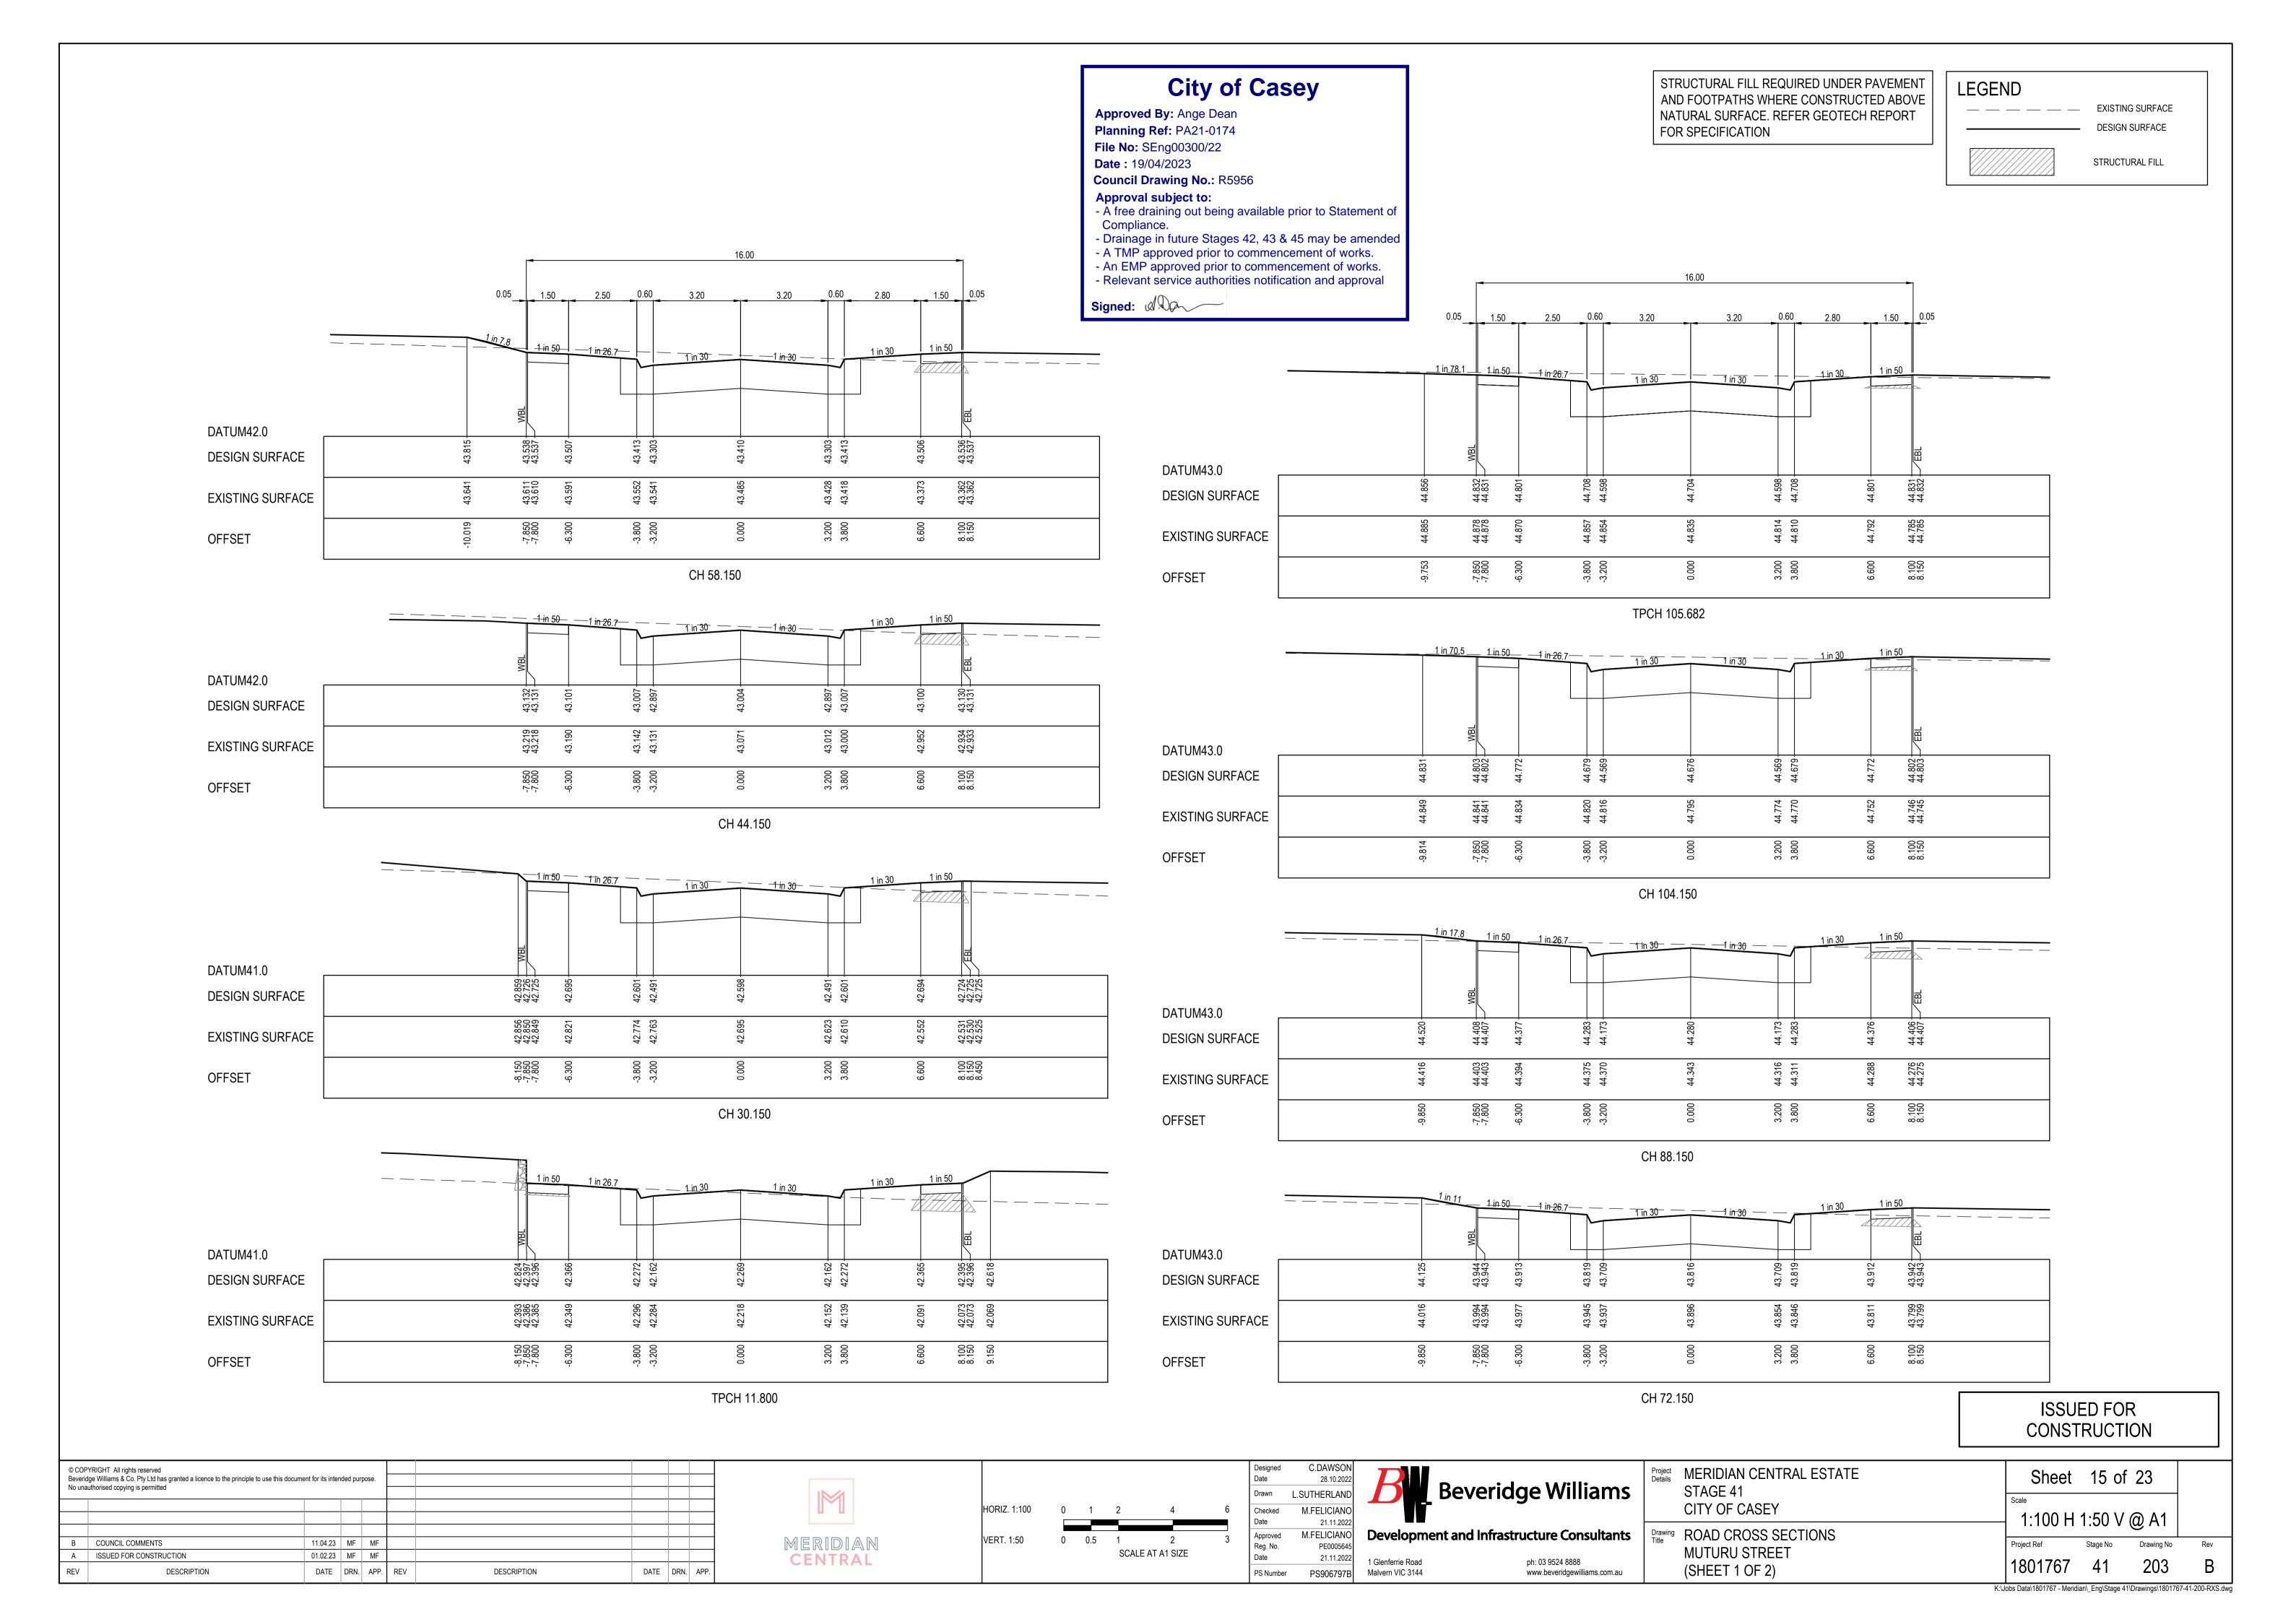








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ructure Consultants	Drawing Title	ROA
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ph: 03 9524 8888 www.beveridgewilliams.com.au		(SHE

MERIDIAN CENTRAL ESTATE STAGE 41	Sheet 14 of 23
CITY OF CASEY	1:100 H 1:50 V @ A1
ROAD CROSS SECTIONS	Project Ref Stage No Drawing No Rev
KHILLARI CIRCUIT (SHEET 2 OF 2)	1801767 41 202 A




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CH 142.668

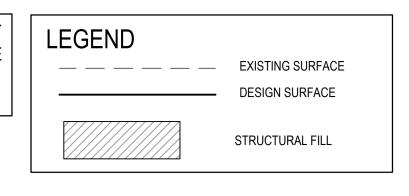

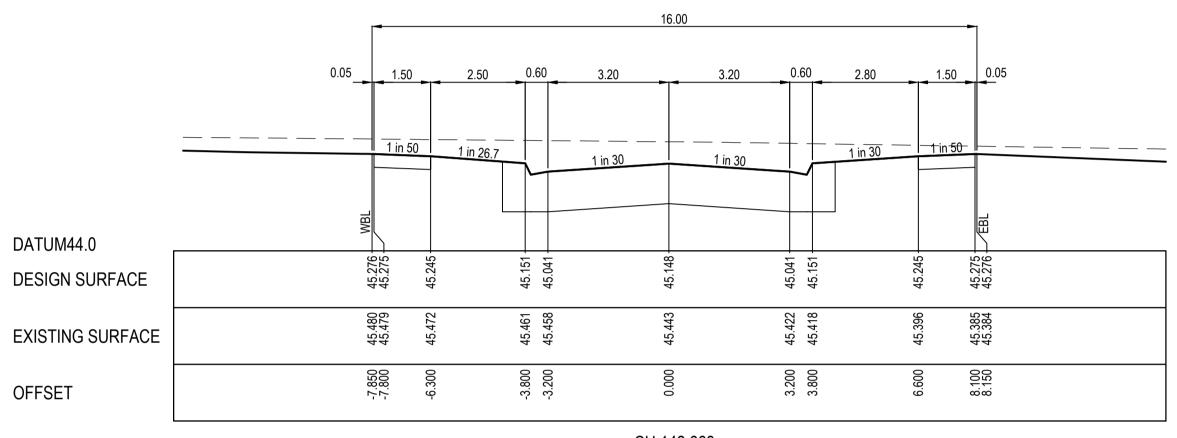City of Casey

Approved By: Ange Dean Planning Ref: PA21-0174 File No: SEng00300/22 Date: 19/04/2023
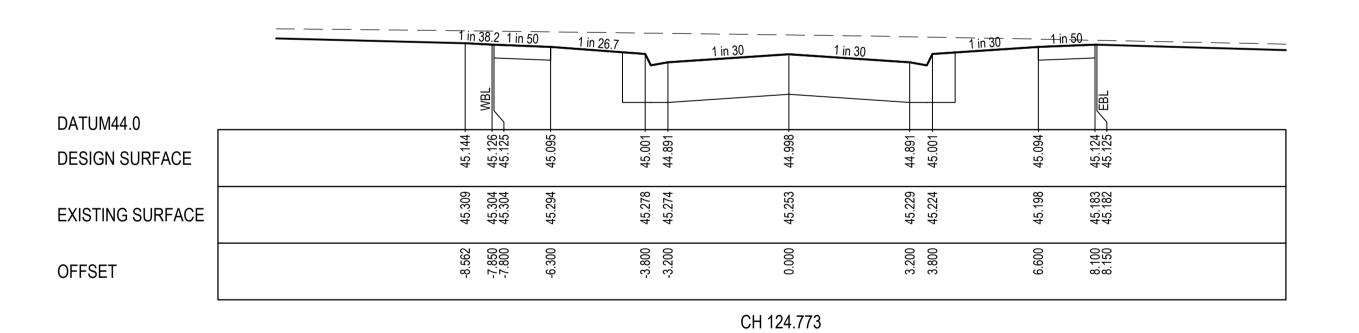
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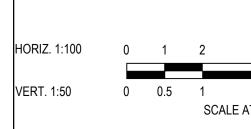
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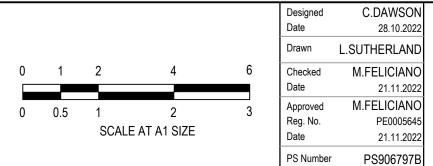
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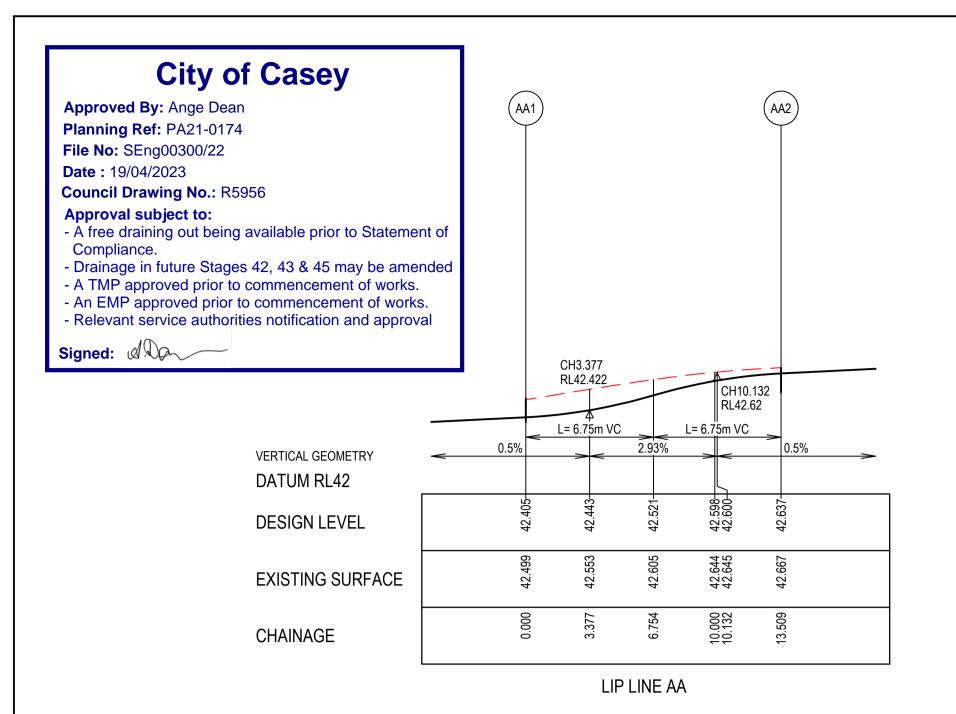






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21.11.2022			
M.FELICIANO	Development and	Infrastructure Consultants	Dr Tit
PE0005645			l '''
21.11.2022	1 Glenferrie Road	ph: 03 9524 8888	
PS906797B	Malvern VIC 3144	www.beveridgewilliams.com.au	

	<u> </u>					
Project Details	MERIDIAN CENTRAL ESTATE STAGE 41	Sheet 16 of 23				
	CITY OF CASEY	Scale 1:100 H	1·50 \/	Δ1		
Orawing Fitle	ROAD CROSS SECTIONS					
	MUTURU STREET (SHEET 2 OF 2)	1801767	Stage No	Drawing No 204	Rev B	



LIP LINE AA


 Point no
 Easting
 Northing
 RL

 AA1
 2482.244
 261.254
 42.405

 AA2
 2474.778
 270.855
 42.637

 Curve no
 I
 Radius
 Arc
 A
 B
 X
 Y
 I
 Mid point RL

 AA1 - AA2
 90.000
 8.600
 13.509
 2.519
 1.864
 3.291
 2.790
 3.377
 42.521

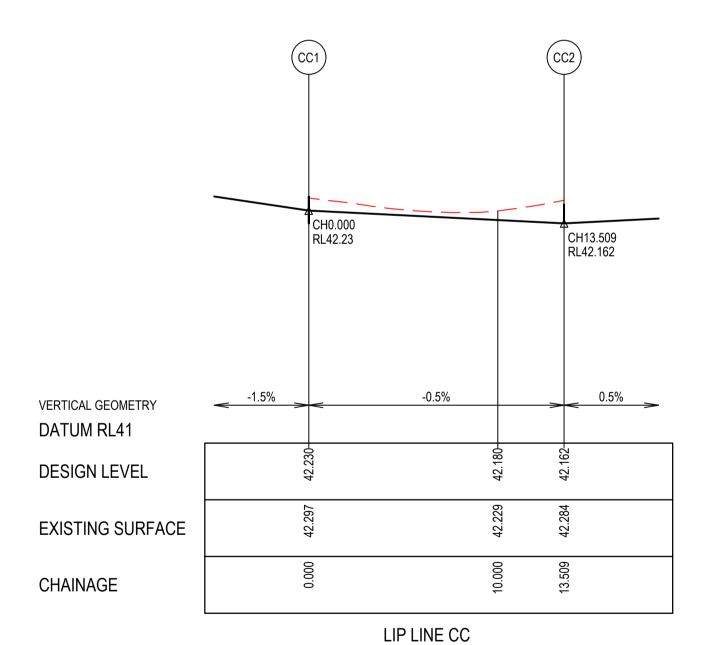

LIP LINE CC


 Point no
 Easting
 Northing
 RL

 CC1
 2523.201
 271.246
 42.230

 CC2
 2532.802
 278.712
 42.162

 Curve no
 I
 Radius
 Arc
 A
 B
 X
 Y
 I
 Mid point RL

 CC1 - CC2
 90.000
 8.600
 13.509
 2.519
 1.864
 3.291
 2.790
 3.377
 42.196

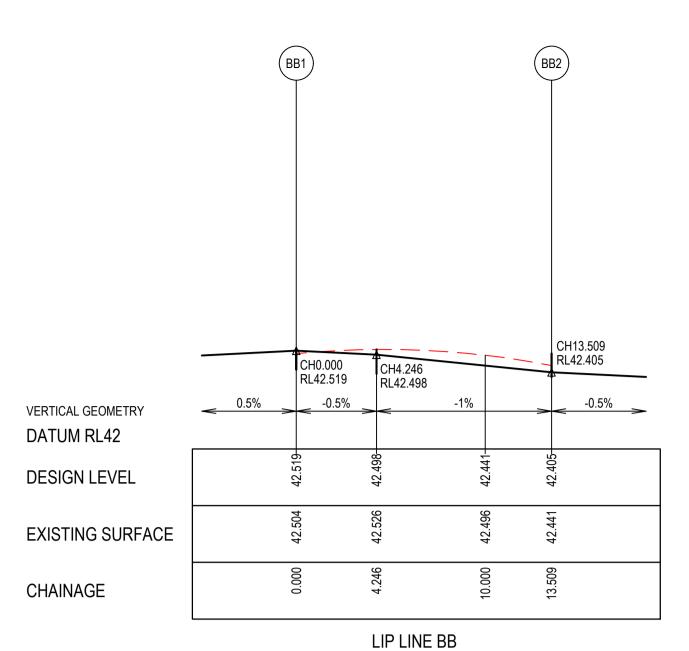

LIP LINE BB


 Point no
 Easting
 Northing
 RL

 BB1
 2498.195
 267.925
 42.519

 BB2
 2488.594
 260.459
 42.405

 Curve no
 I
 Radius
 Arc
 A
 B
 X
 Y
 I
 Mid point RL

 BB1 - BB2
 90.000
 8.600
 13.509
 2.519
 1.864
 3.291
 2.790
 3.377
 42.473

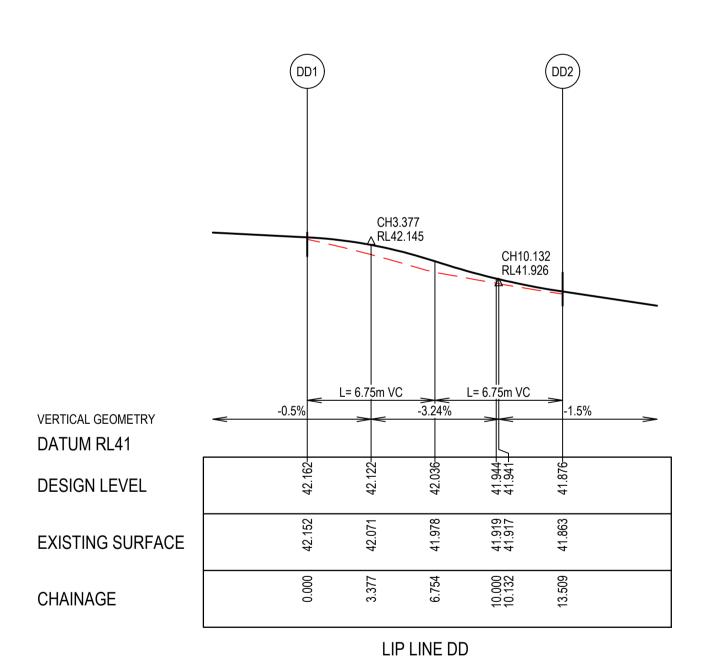

LIP LINE DD

Point no Easting Northing RL
DD1 2539.152 277.918 42.162
DD2 2546.618 268.317 41.876

 Curve no
 I
 Radius
 Arc
 A
 B
 X
 Y
 I
 Mid point RL

 DD1 - DD2
 90.000
 8.600
 13.509
 2.519
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 3.291
 2.790
 3.377
 42.036

Approved


Reg. No.


21.11.2022


PS906797B


1 Glenferrie Road

Malvern VIC 3144

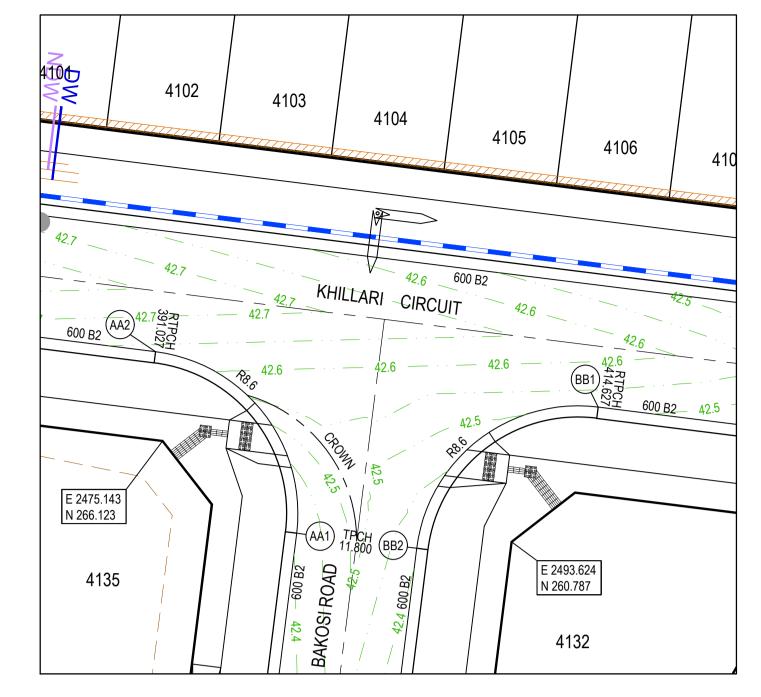


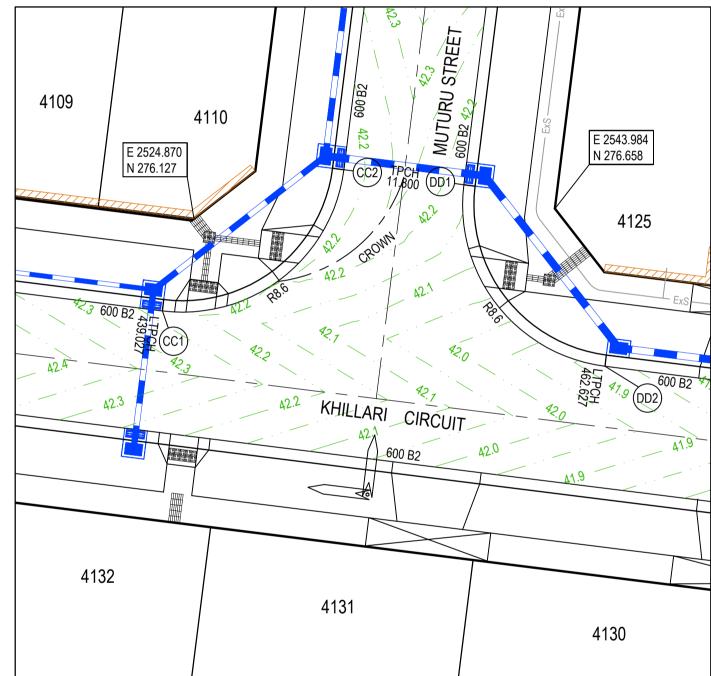

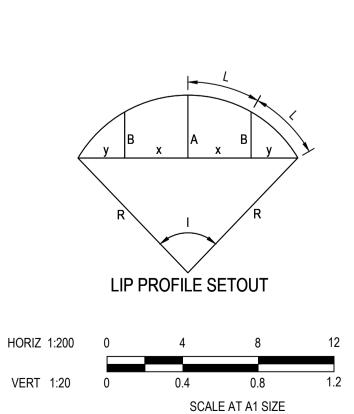

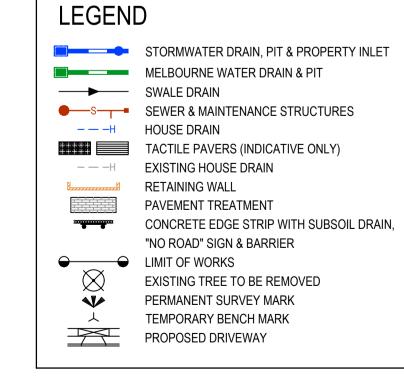

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10 2022	C.DAWSON 28.10.2022	• I \ \ A #011e
RLAND Beveridge William	L.SUTHERLAND	reridge Williams
	M.FELICIANO 21.11.2022	_
CIANO Development and Infrastructure Consult	M.FELICIANO PE0005645	Infrastructure Consultants

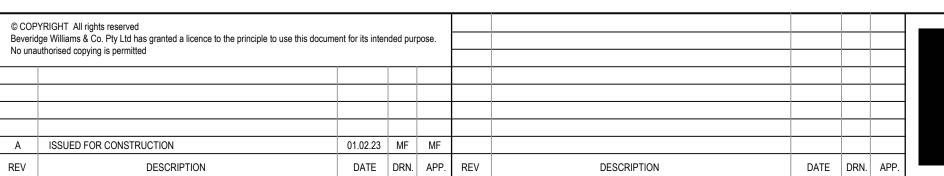ph: 03 9524 8888

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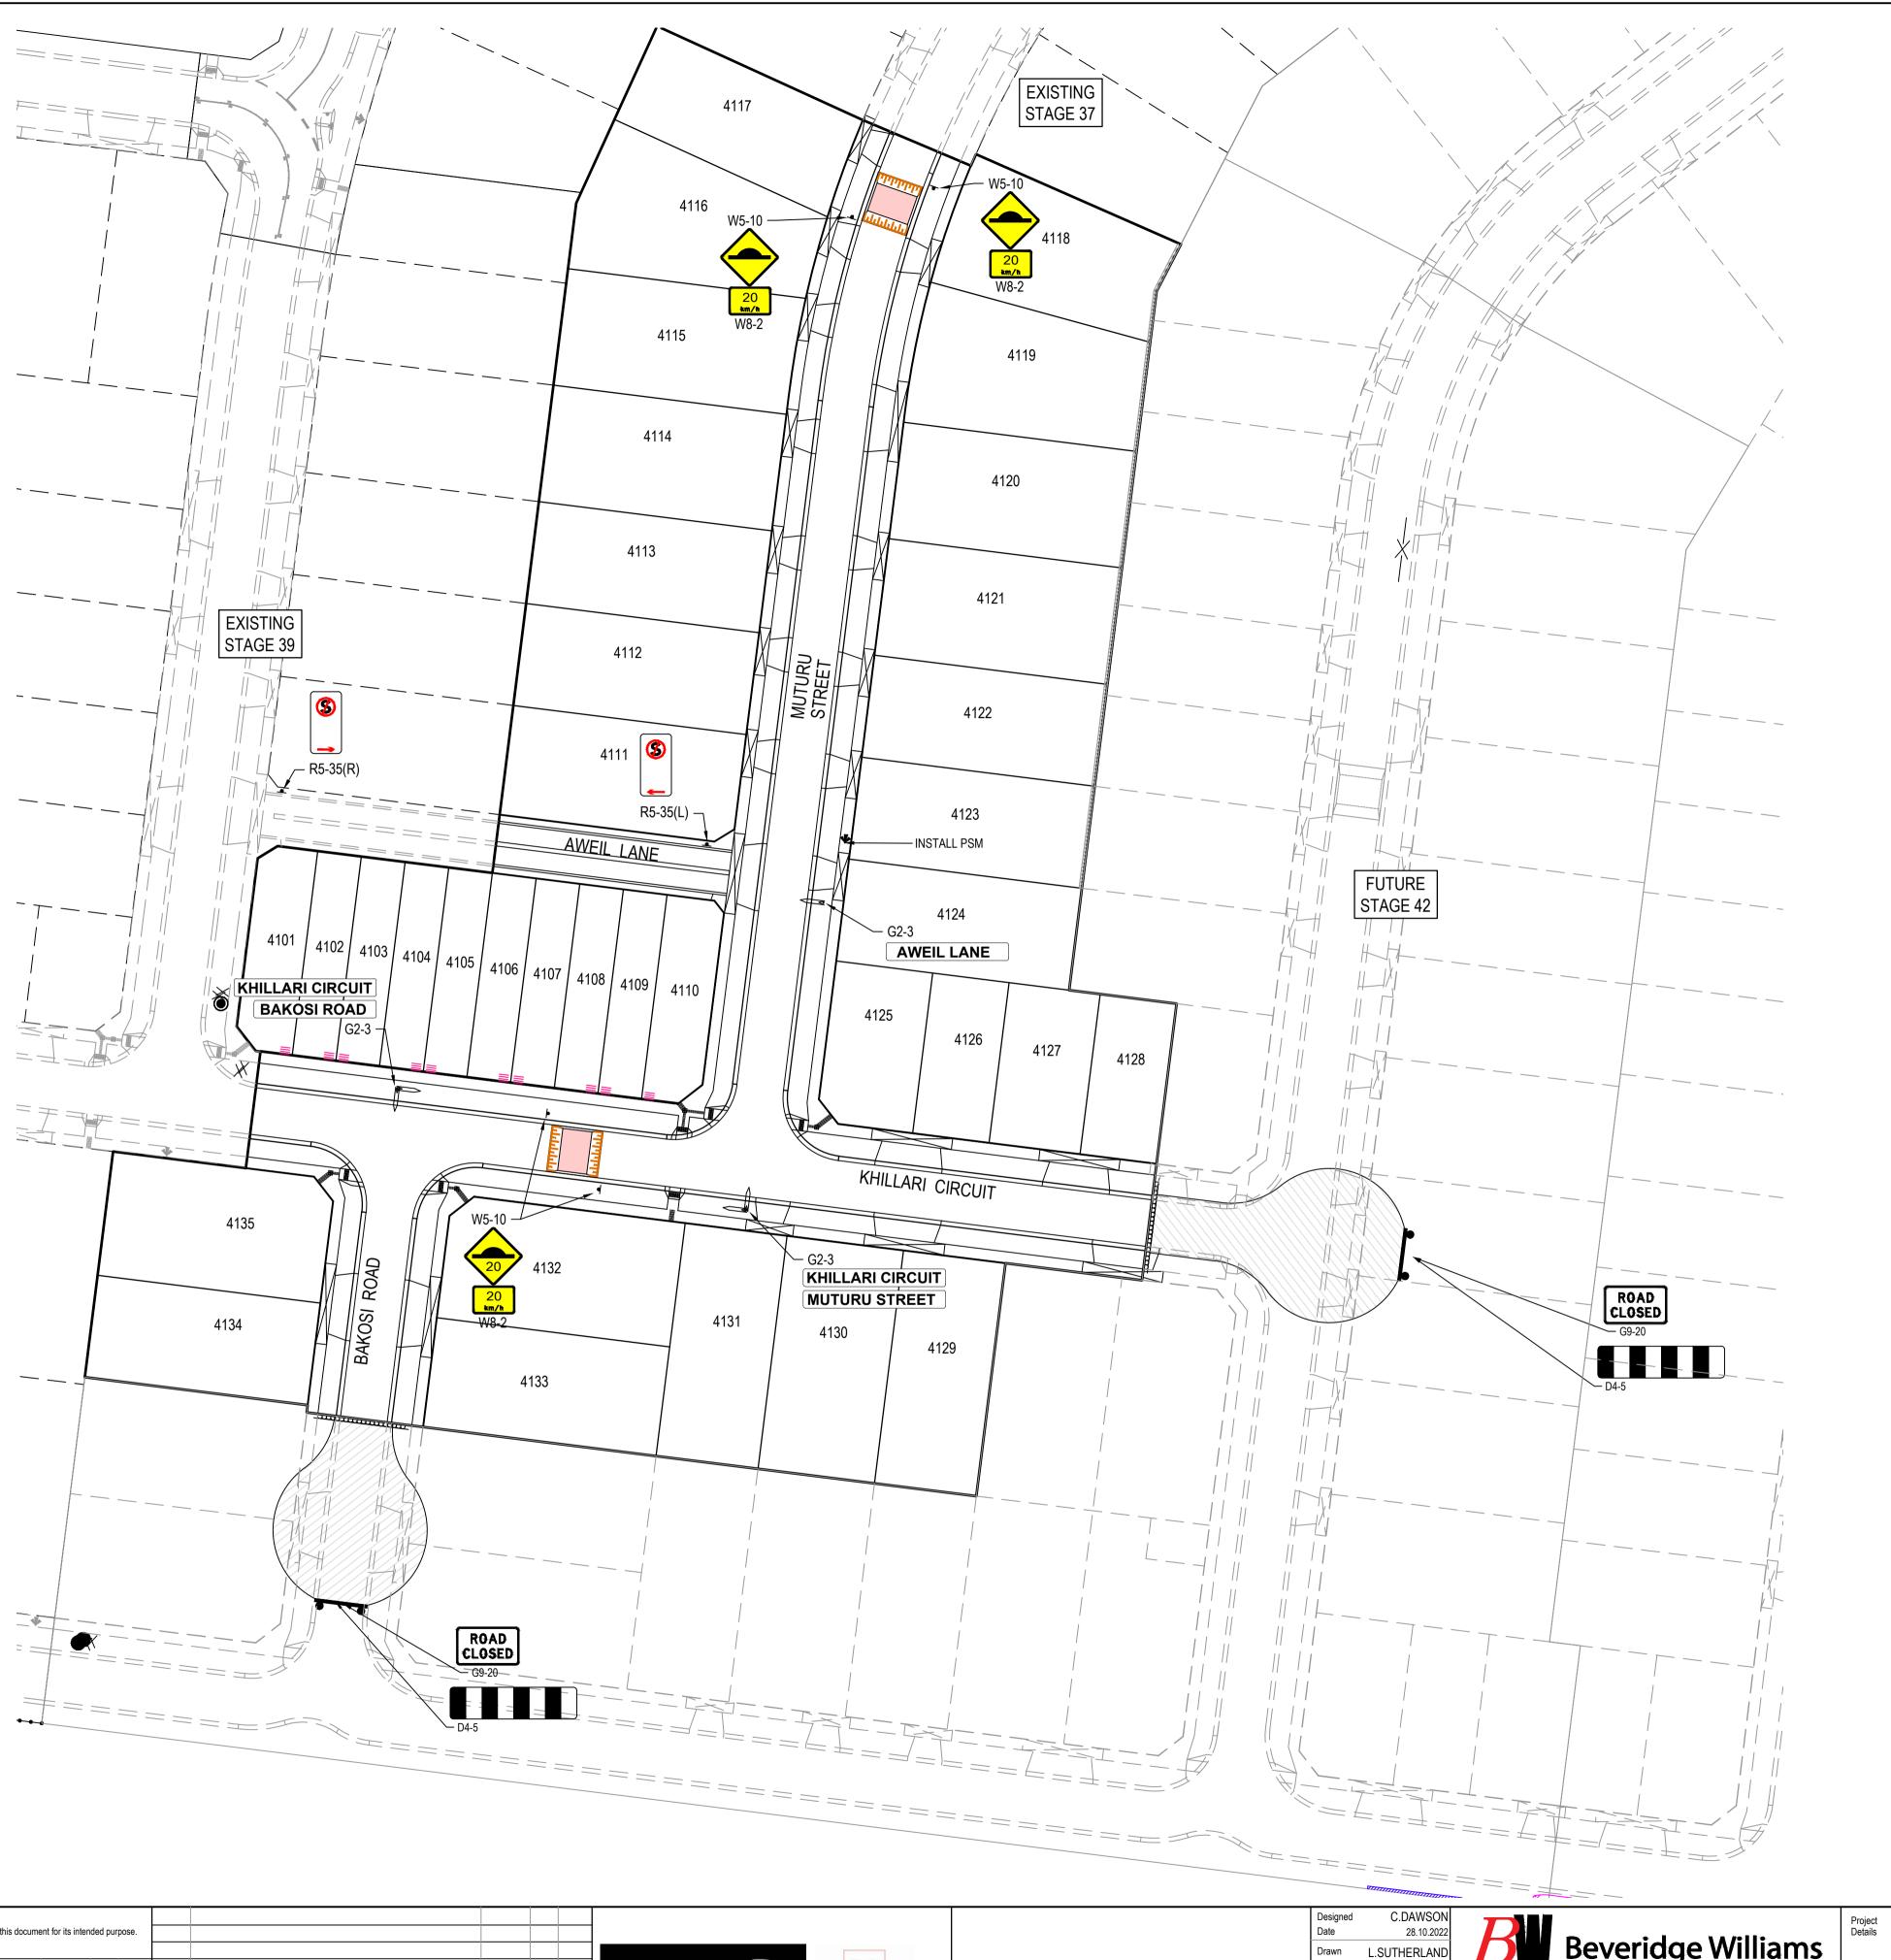
roject etails	MERIDIAN CENTRAL ESTATE
	STAGE 41
	CITY OF CASEY

Drawing INTERSECTION DETAILS

Sheet	17 of	23	/
Scale			16
1:200 H	1:20 V	@ A1	`
Project Ref	Stage No	Drawing No	

Stage No Drawing No Rev
767 41 300 A

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Approved By: Ange Dean Planning Ref: PA21-0174

File No: SEng00300/22 **Date:** 19/04/2023 Council Drawing No.: R5956

Approval subject to:
- A free draining out being available prior to Statement of Compliance.

- Drainage in future Stages 42, 43 & 45 may be amended
- A TMP approved prior to commencement of works. - An EMP approved prior to commencement of works.
- Relevant service authorities notification and approval

Signed:

- RRPM'S AT MAX 6m SPACING.
- LINEMARKING TO BE EXTENDED AT LEAST 6m FROM THE TANGENT POINT
- LINEMARKING IN ACCORDANCE WITH AS1742.
- TGSI TO BE INSTALLED IN ACCORDANCE WITH AS1428.4 & VICROADS SUPPLEMENTARY STANDARD TEM Vol 2 Part 2.23 ALL STREET NAME SIGNS AT INTERSECTIONS TO INCLUDE RELEVANT STREET NUMBERING.
- ALL LINE MARKING PAINT SHALL BE LONG LIFE TYPE. LATERAL WORKS AND ARROWS BEING COLD APPLIED PLASTIC TROWELLED INTO PLACE (MATERIAL DEGADUR
- PLASTELINE) AND LONGITUDINAL LINES BEING EXTRUDED THERMOPLASTIC MATERIAL.

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В	COUNCIL COMMENTS	11.04.23	MF	MF					
Α	ISSUED FOR CONSTRUCTION	01.02.23	MF	MF					
REV	DESCRIPTION	DATE	DRN.	APP.	REV	DESCRIPTION	DATE	DRN.	APP.





Approved

PS Number

21.11.2022

PS906797B

1 Glenferrie Road

Malvern VIC 3144

Reg. No.



ph: 03 9524 8888

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Project Details MERIDIAN CENTRAL ESTATE STAGE 41 CITY OF CASEY

Drawing SIGNAGE & LINE MARKING PLANS

Sheet 18 of 23 1:500 @ A1 Drawing No

Approved By: Ange Dean Planning Ref: PA21-0174 File No: SEng00300/22

Date: 19/04/2023 Council Drawing No.: R5956

Approval subject to:

- A free draining out being available prior to Statement of Compliance.


Drainage in future Stages 42, 43 & 45 may be amended
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 Relevant service authorities notification and approval

Signed:

NOTES:
ALL STORMWATER DRAINS UP TO AND INCLUDING 750mm DIA. ARE TO BE CLASS 2 R.R.J. PIPES UNLESS NOTED OTHERWISE.


— — — — EXISTING SURFACE DESIGN SURFACE DRAINAGE PIPE/PIT — — — EXISTING DRAINAGE PIPE/PIT — HYDRAULIC GRADE LINE DENOTES 20mm CLASS 3 FCR BACKFILL.

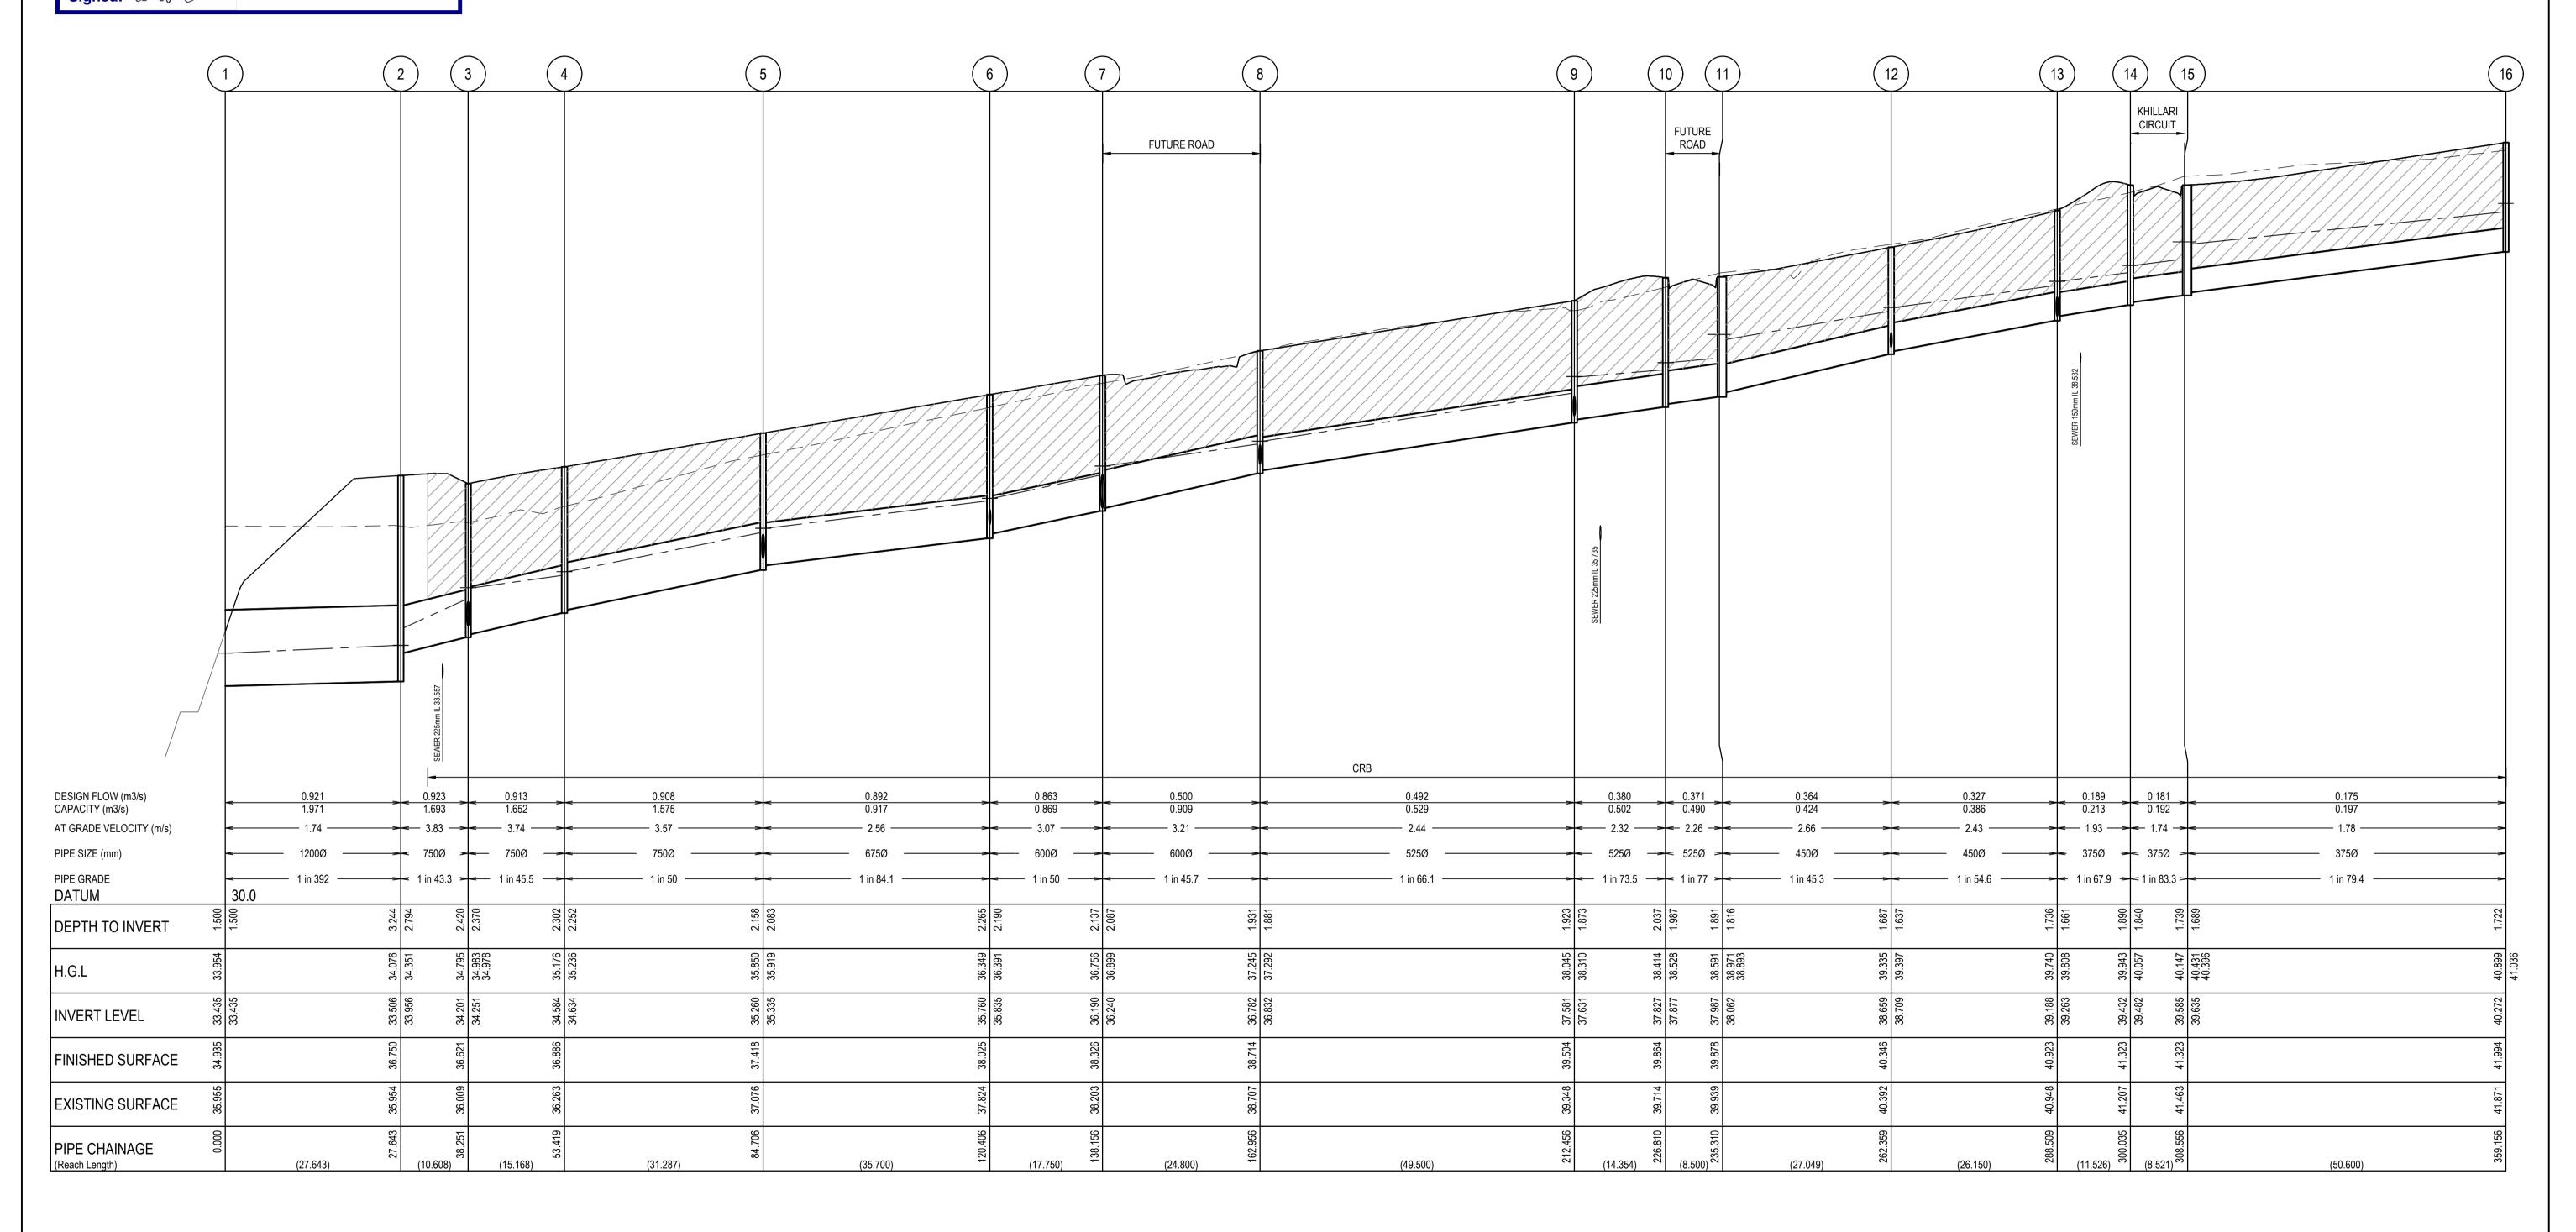

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REV	DESCRIPTION	DATE	DRN.	APP.	REV	DESCRIPTION	DATE	DRN.	APP.





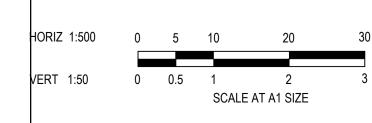

Reg. No.

21.11.2022

PS Number PS906797B Malvern VIC 3144

1 Glenferrie Road

	C.DAWSON 28.10.2022	d
Beveridge William	L.SUTHERLAND	
	M.FELICIANO	
	21.11.2022	
evelopment and Infrastructure Consultar	M.FELICIANO	d
	PE0005645	

ph: 03 9524 8888

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ìS	Project Details	MERIDIAN CENTRAL ESTATE STAGE 41 CITY OF CASEY
nts	Drawing Title	DRAINAGE LONGITUDINAL SECTIONS (SHEET 1 OF 4)

CONST	RUCT	ION	
Sheet	19 o	f 23	
1:500 H	1:50 V	@ A1	
Project Ref	Stage No	Drawing No	R
1801767	41	400	

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ISSUED FOR

Approved By: Ange Dean Planning Ref: PA21-0174 File No: SEng00300/22 **Date:** 19/04/2023

Council Drawing No.: R5956

Approval subject to:

- A free draining out being available prior to Statement of

- Drainage in future Stages 42, 43 & 45 may be amended


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- An EMP approved prior to commencement of works. - Relevant service authorities notification and approval

Signed:

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— — — — EXISTING SURFACE DESIGN SURFACE DRAINAGE PIPE/PIT – — — EXISTING DRAINAGE PIPE/PIT — HYDRAULIC GRADE LINE DENOTES 20mm CLASS 3 FCR BACKFILL.

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CONSTRUCTION Project Details MERIDIAN CENTRAL ESTATE © COPYRIGHT All rights reserved Sheet 20 of 23 Beveridge Williams & Co. Pty Ltd has granted a licence to the principle to use this document for its intended purpose. Beveridge Williams STAGE 41 No unauthorised copying is permitted Drawn L.SUTHERLAND CITY OF CASEY HORIZ 1:500 M.FELICIANO 1:500 H 1:50 V @ A1 Drawing Title DRAINAGE LONGITUDINAL SECTIONS Development and Infrastructure Consultants MERIDIAN CENTRAL M.FELICIANO Approved VERT 1:50 Project Ref Reg. No. PE0005645 Drawing No (SHEET 2 OF 4) SCALE AT A1 SIZE A ISSUED FOR CONSTRUCTION 01.02.23 MF MF 21.11.2022 1 Glenferrie Road ph: 03 9524 8888 DATE DRN. APP. REV DESCRIPTION DATE DRN. APP Malvern VIC 3144 www.beveridgewilliams.com.au PS906797B

Approved By: Ange Dean Planning Ref: PA21-0174 File No: SEng00300/22 **Date:** 19/04/2023

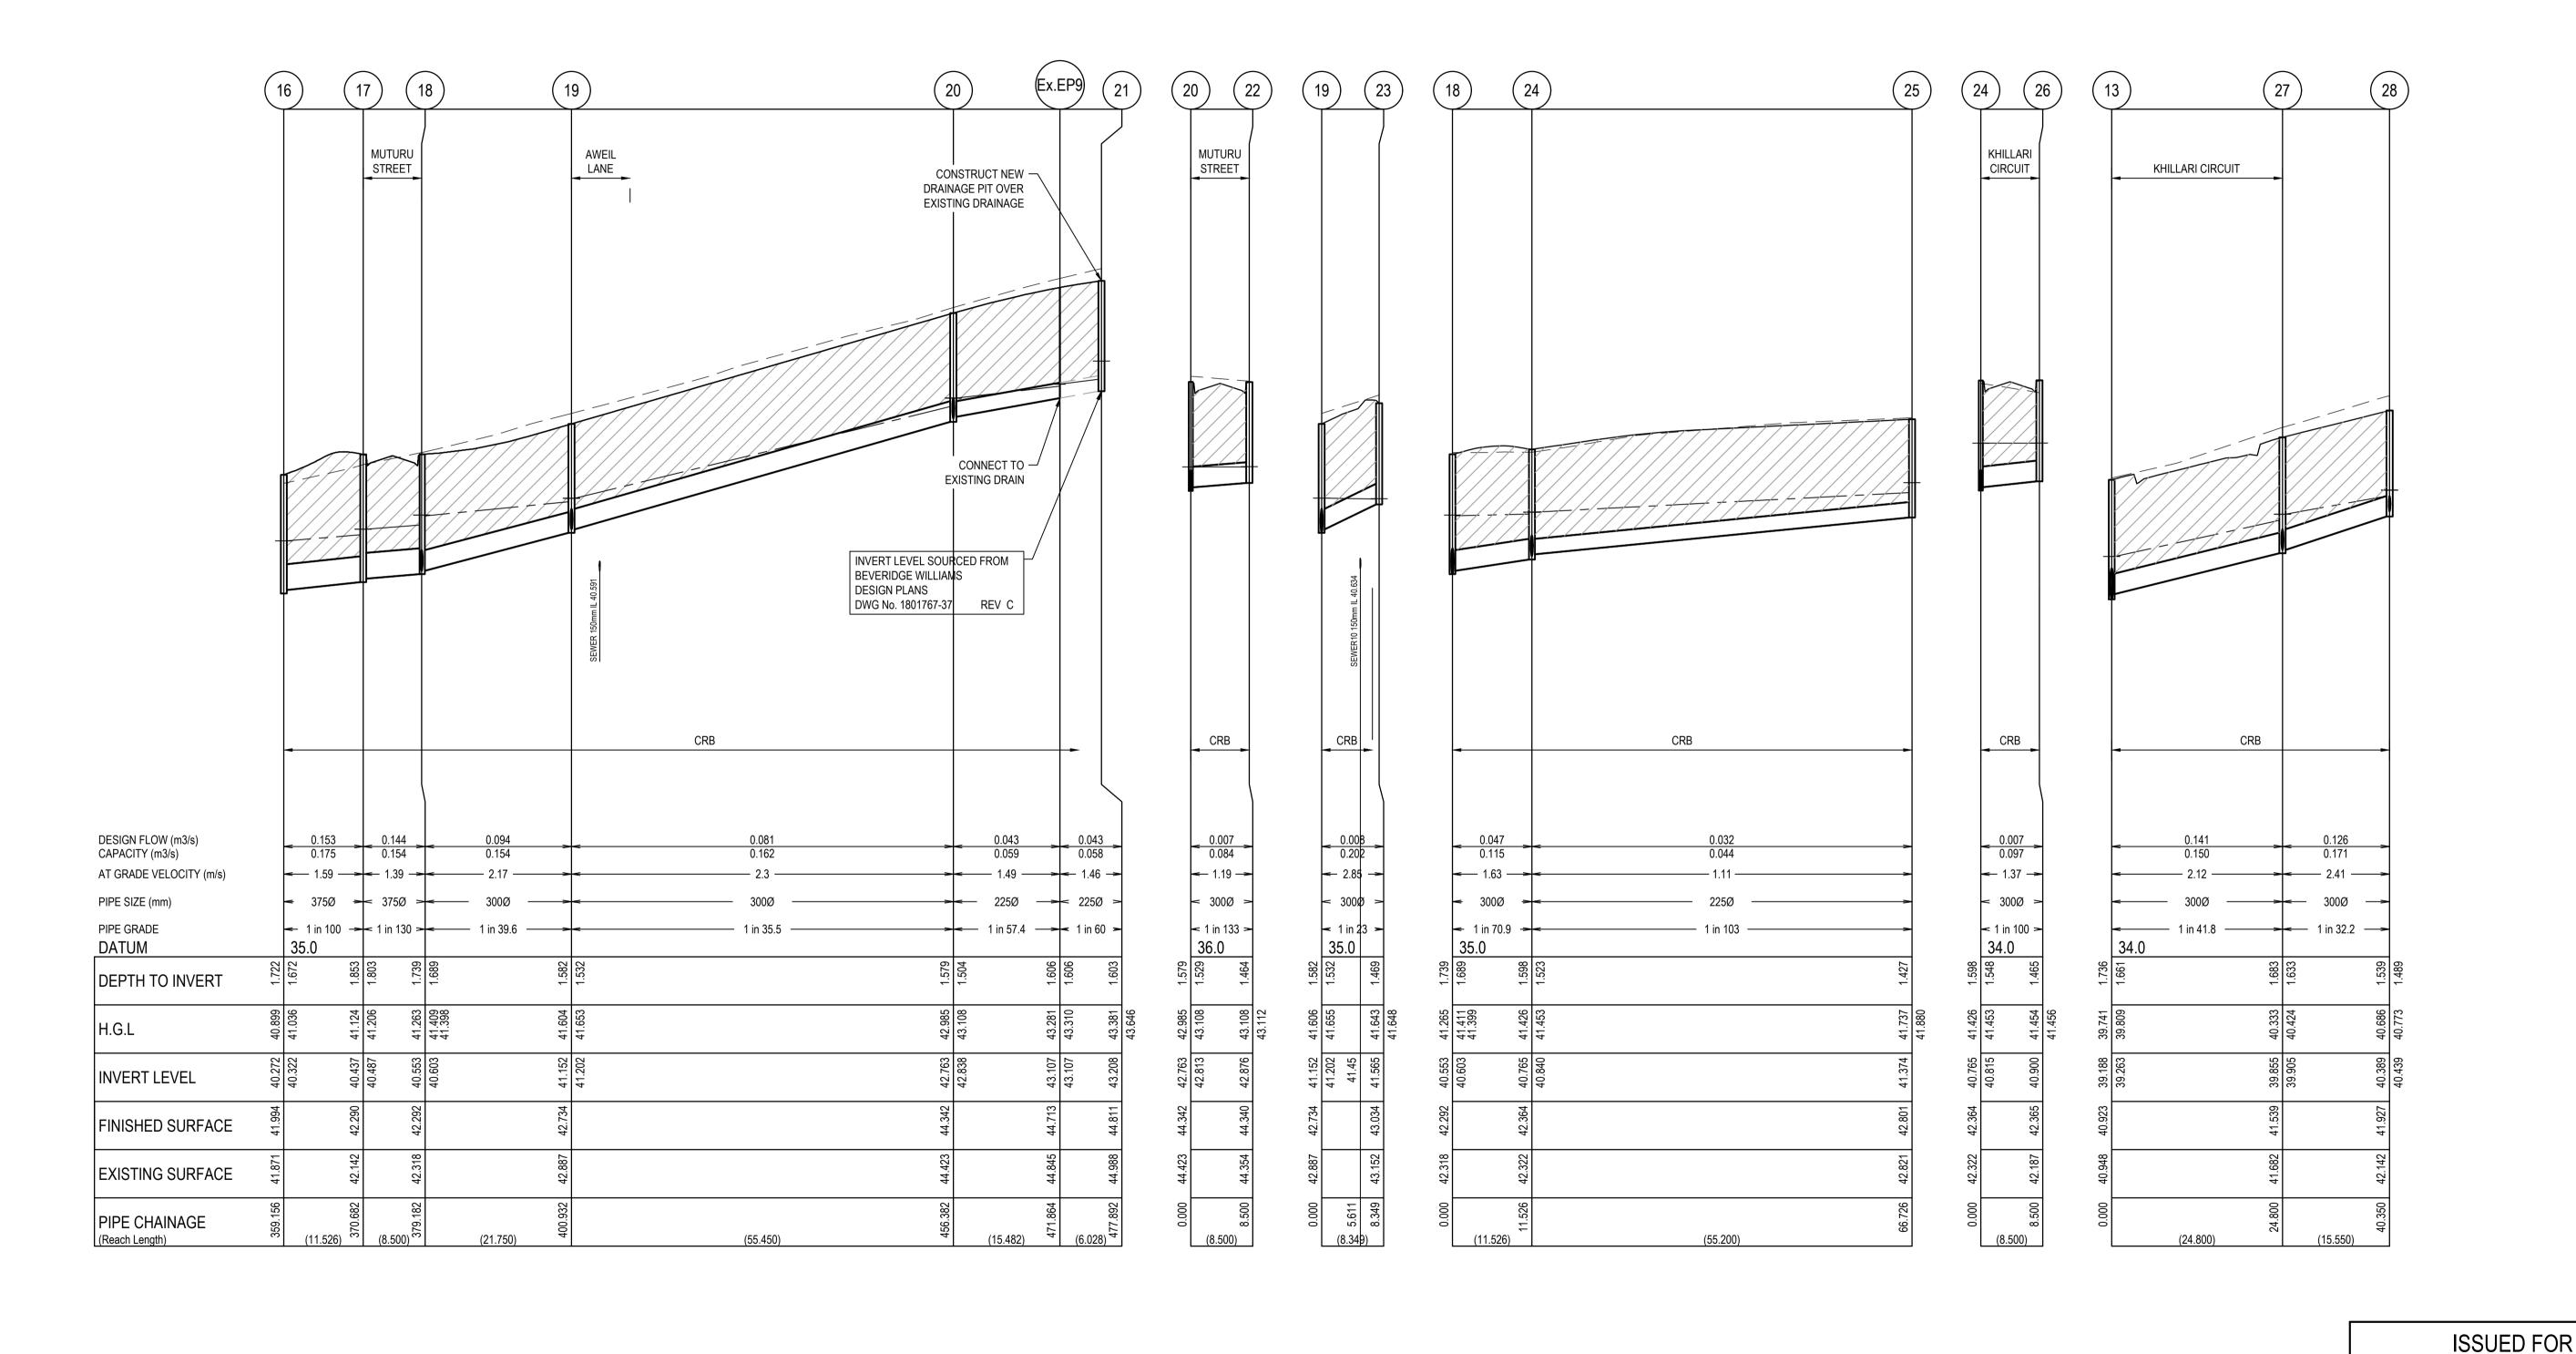Council Drawing No.: R5956

Approval subject to:
- A free draining out being available prior to Statement of


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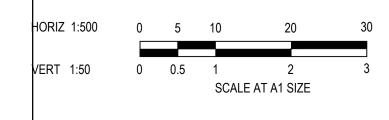
— — — — EXISTING SURFACE DESIGN SURFACE DRAINAGE PIPE/PIT — — — EXISTING DRAINAGE PIPE/PIT — HYDRAULIC GRADE LINE DENOTES 20mm CLASS 3 FCR BACKFILL.




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REV	DESCRIPTION	DATE	DRN.	APP.	REV	DESCRIPTION	DATE	DRN.	APP.





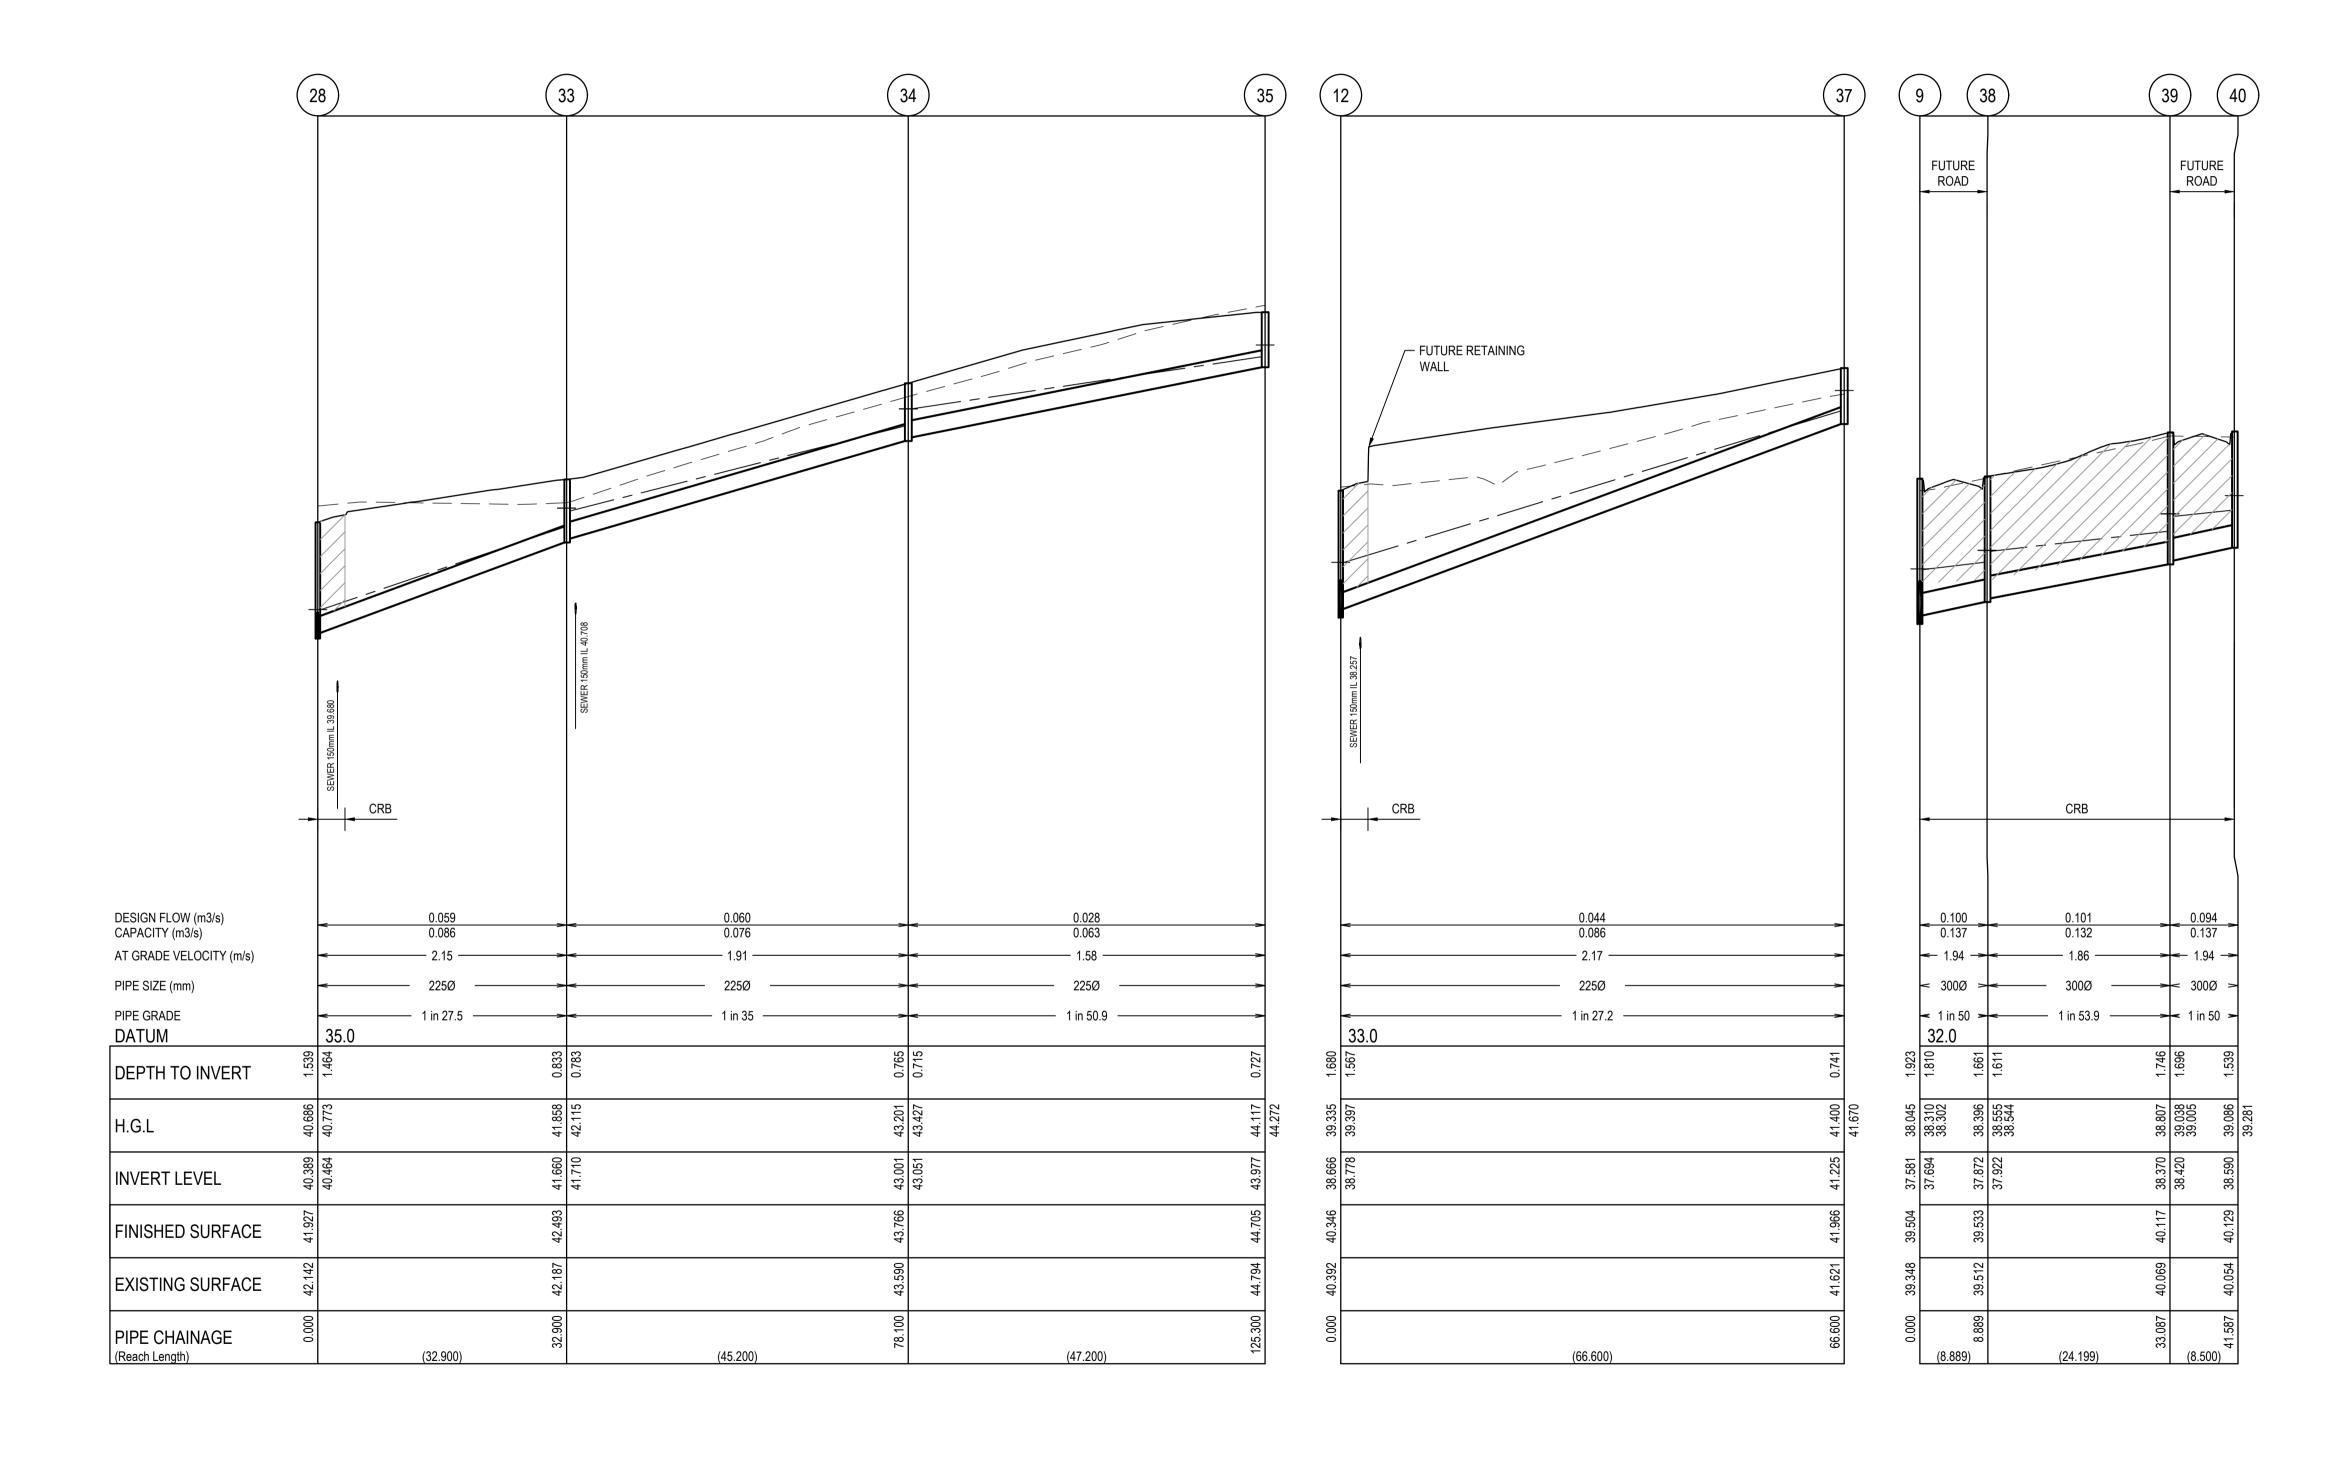

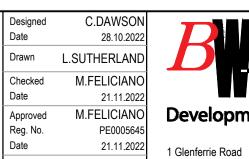Malvern VIC 3144

PS906797B

Approved

Reg. No. Date



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Project Details	MERIDIAN CENTRAL ESTATE STAGE 41 CITY OF CASEY
Drawing Title	DRAINAGE LONGITUDINAL SECTIONS (SHEET 3 OF 4)

Sheet 21 of 23 1:500 H 1:50 V @ A1 Drawing No


Approved By: Ange Dean Planning Ref: PA21-0174 File No: SEng00300/22 **Date:** 19/04/2023


Council Drawing No.: R5956

Approval subject to:
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 Relevant service authorities notification and approval

Signed:



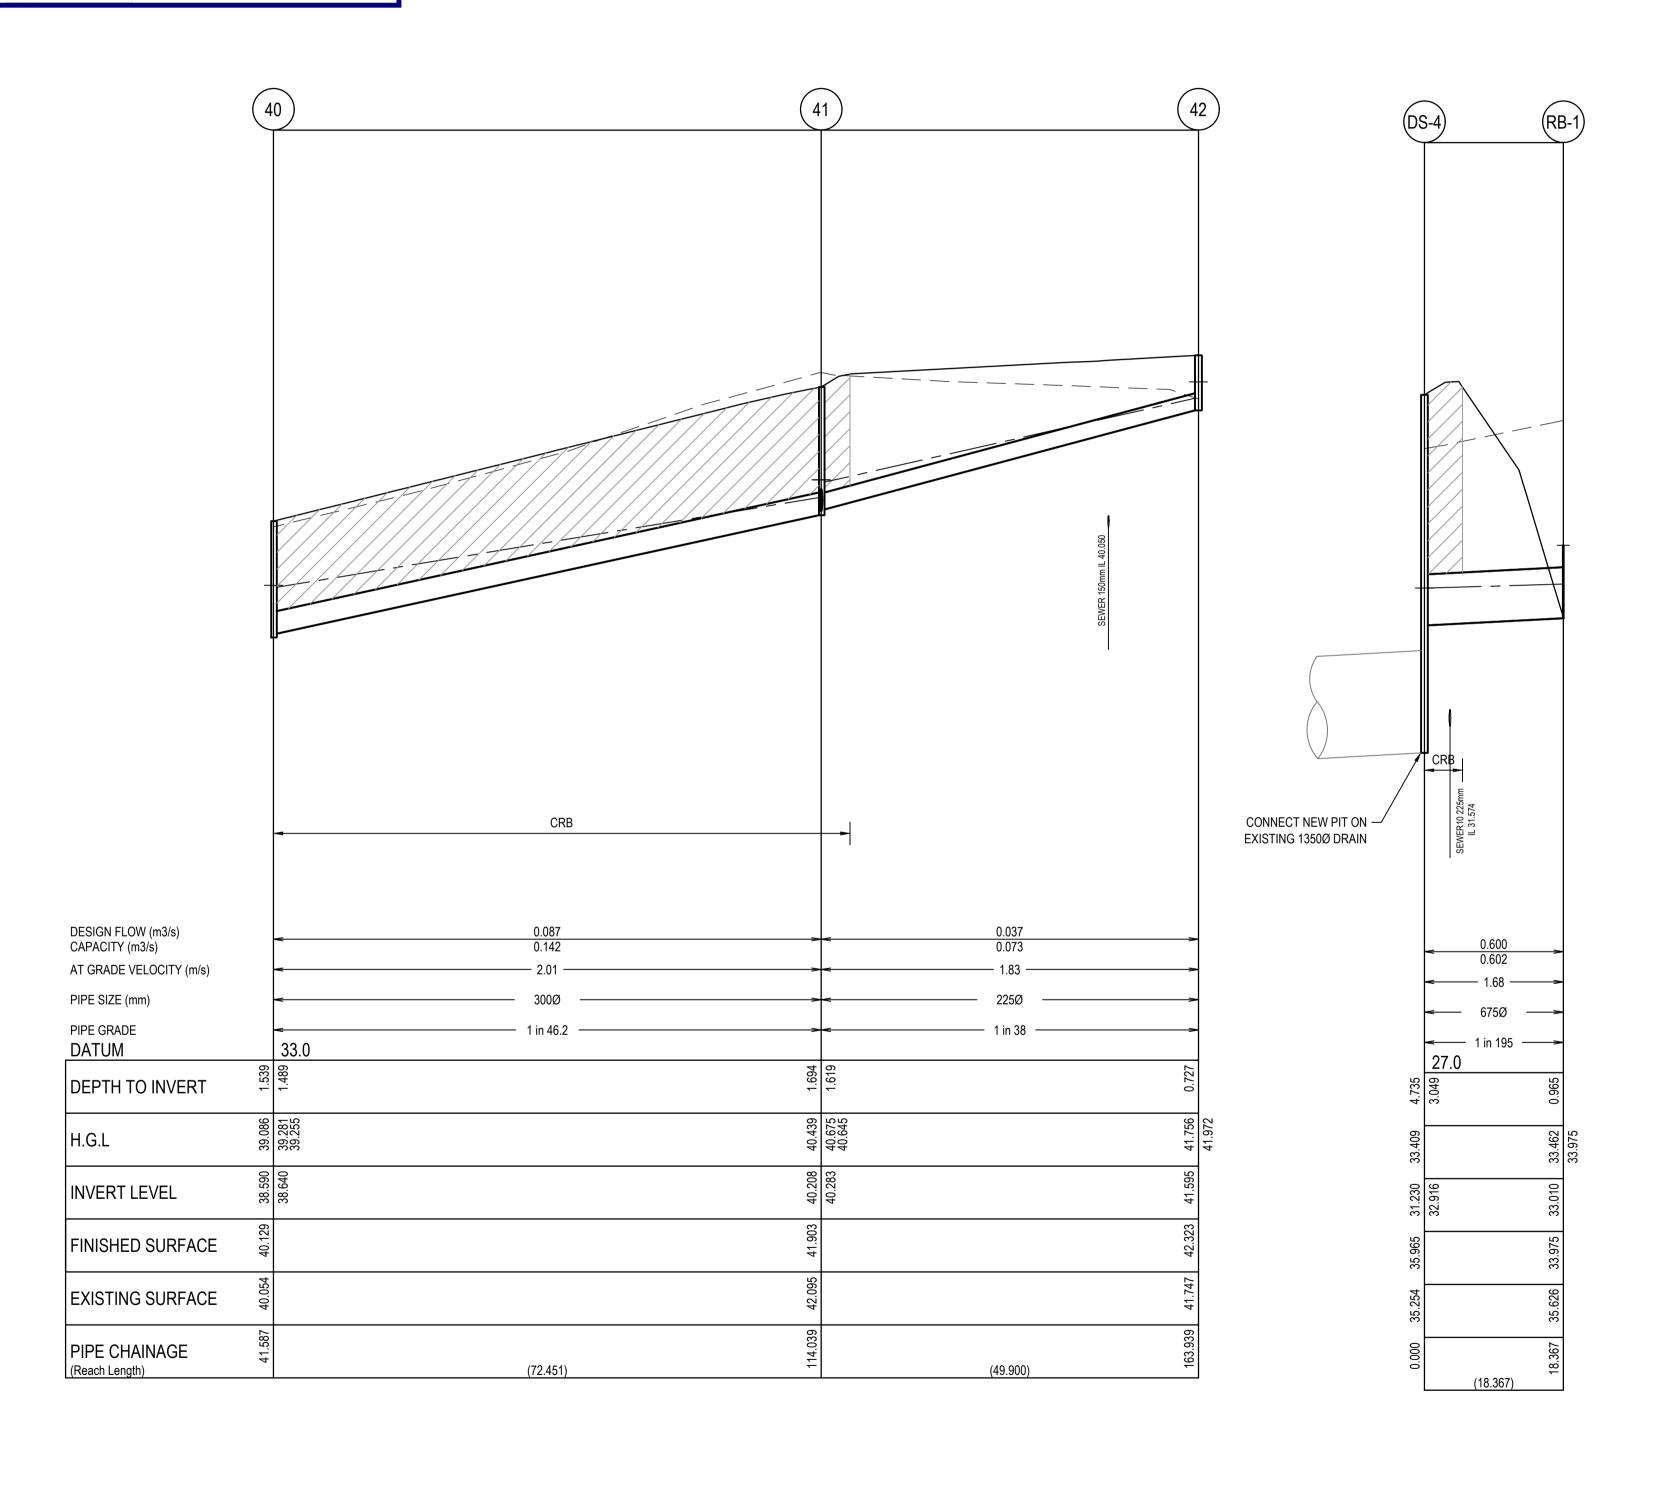

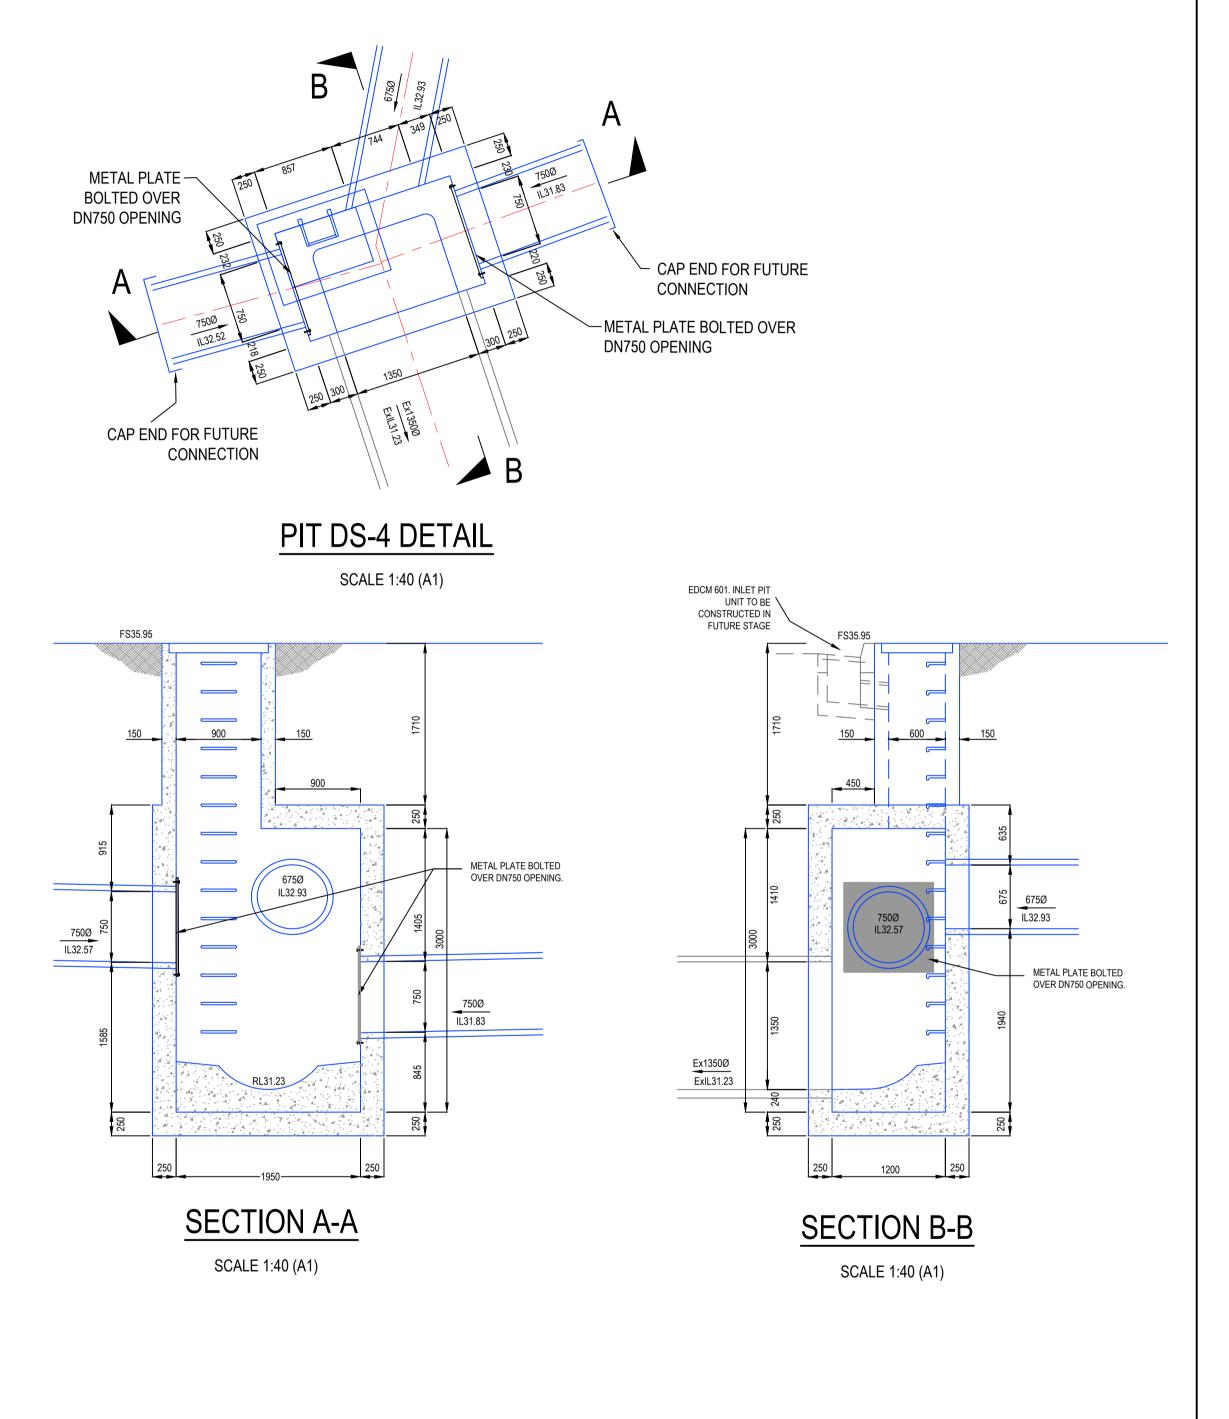NOTES:
ALL STORMWATER DRAINS UP TO AND

INCLUDING 750mm DIA. ARE TO BE CLASS 2

R.R.J. PIPES UNLESS NOTED OTHERWISE.

— — — EXISTING SURFACE

DESIGN SURFACE

DRAINAGE PIPE/PIT

HYDRAULIC GRADE LINE

DENOTES 20mm CLASS 3 FCR BACKFILL.


— — EXISTING DRAINAGE PIPE/PIT


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Α	ISSUED FOR CONSTRUCTION	01.02.23	MF	MF					
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M.FELICIANO

PE0005645

21.11.2022

PS906797B

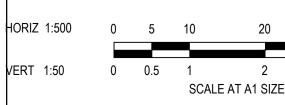1 Glenferrie Road

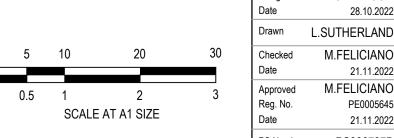Malvern VIC 3144



ph: 03 9524 8888

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Project Details	MERIDIAN CENTRAL ESTATE STAGE 41 CITY OF CASEY
Drawing Title	DRAINAGE LONGITUDINAL SECTIONS (SHEET 4 OF 4)

AND PIT DETAILS

Sheet	22 of	23	
1:500 H	1:50 V	@ A1	
Project Ref	Stage No	Drawing No	I
1801767	41	403	

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	1					1		T SCHEDULE			
PIT NAME	PIT TYPE	WIDTH	RNAL LENGTH	DIA	NLET INV LEV	DIA	INV LEV	PIT SETOUT RL	DEPTH	- STD DWG	REMARKS
1	MASS CONCRETE ENDWALL	-	_			1200	33.435	34.935	1.500	VICROADS SD1821	INSTALL ROCKBEACHING FOR INLET PIPE TO TEMPORARY RETARDING BASIN
2	JUNCTION PIT	600(T)	900(T)	750	33.956	1200	33.506	36.750	3.244	EDCM 607	
		600(B)	1500(B)								
3	DOUBLE GRATED SIDE ENTRY PIT	600(T)	900(T)	750	34.251	750	34.201	36.621	2.420	EDCM 602/607	HAUNCH UNDER ROAD. PROVIDE TEMPORARY PIT COVER
		1200(B)	1500(B)	375	34.388						REFER THIS SHEET FOR PIT DETAILS
4	DOUBLE GRATED SIDE ENTRY PIT	600(T)	900(T)	750	34.634	750	34.584	36.886	2.302	EDCM 602/607	HAUNCH UNDER ROAD. PROVIDE TEMPORARY PIT COVER
		1050(B)	900(B)								
5	DOUBLE GRATED SIDE ENTRY PIT	600(T)	900(T)	675	35.335	750	35.260	37.42	2.16	EDCM 602/607	HAUNCH UNDER ROAD. PROVIDE TEMPORARY PIT COVER
		1050(B)	900(B)	375	35.448						
6	GRATED SIDE ENTRY PIT	600(T)	900(T)	600	35.835	675	35.760	38.03	2.27	EDCM 601 / 607	HAUNCH UNDER ROAD. PROVIDE TEMPORARY PIT COVER
		900(B)	900(B)	225	35.985						
7	GRATED SIDE ENTRY PIT	600(T)	900(T)	600	36.240	600	36.190	38.33	2.14	EDCM 601 / 607	HAUNCH UNDER ROAD. PROVIDE TEMPORARY PIT COVER
		900(B)	1050(B)	525	36.240						
8	GRATED SIDE ENTRY PIT	600(T)	900(T)	525	36.832	600	36.782	38.71	1.93	EDCM 601/607	HAUNCH UNDER ROAD. PROVIDE TEMPORARY PIT COVER
		900(B)	900(B)	300	36.932						
9	JUNCTION PIT	600(T)	900(T)	525	37.631	525	37.581	39.50	1.92	EDCM 607	HAUNCH UNDER ROAD. PROVIDE TEMPORARY PIT COVER
		1050(B)	900(B)	300	37.694				1		
10	GRATED SIDE ENTRY PIT	600(T)	900(T)	525	37.877	525	37.827	39.86	2.04	EDCM 601/607	HAUNCH UNDER ROAD. PROVIDE TEMPORARY PIT COVER
	9101125 0152 211111111	1050(B)	900(B)	020	01.011	020	07.027	00.00	2.01		Interest of the Entire transfer of the transfe
11	GRATED SIDE ENTRY PIT	600	900	450	38.062	525	37.987	39.87	1.89	EDCM 601/605	PROVIDE TEMPORARY PIT COVER
12	JUNCTION PIT	600	900	450	38.709	450	38.659	40.35	1.68	EDCM 605	PROVIDE TEMPORARY PIT COVER
12	JONOTICITI	000	300	225	38.772	+30	30.033	+0.55	1.00	EDCIVI 003	TROVIDE TEIVII GRART FIT COVER
13	JUNCTION PIT	600	900	375	39.263	450	39.188	40.92	1.74	EDCM 605	PROVIDE TEMPORARY PIT COVER
13	JONGTION FIT	000	300	300	39.263	430	39.100	40.32	1.74	EBOW 000	PROVIDE TEINFORART FIT COVER
14	GRATED SIDE ENTRY PIT	600	900	375	39.482	375	39.432	41.32	1.89	EDCM 601/605	PROVIDE TEMPORARY PIT COVER
											PROVIDE TEMPORARY PIT COVER
15	GRATED SIDE ENTRY PIT	600	900	375	39.635	375	39.585	41.32	1.74		PROVIDE TEINFORART FIT COVER
16	JUNCTION PIT	600	900	375	40.322	375	40.272	41.99	1.72	EDCM 601 /605	
17	GRATED SIDE ENTRY PIT	600	900	375	40.487	375	40.437	42.29	1.85	EDCM 601/605	
18	GRATED SIDE ENTRY PIT	600	900	300	40.603	375	40.553	42.29	1.74	EDCM 601/605	
	ODATED OUDE ENTRY RIT	000	000	300	40.603	200	44.450	40.70	4.50	EDOM 004/005	
19	GRATED SIDE ENTRY PIT	600	900	300	41.202	300	41.152	42.73	1.58	EDCM 601/605	
				300	41.202		40 -00		4 ==	EDOM 004/005	
20	GRATED SIDE ENTRY PIT	600	900	225	42.838	300	42.763	44.34	1.58	EDCM 601/605	
				300	42.813						
Ex.EP9	END PIPE			225	43.107	225	43.107	44.71	1.61		CONNECT TO EXISTING END PIPE
21	JUNCTION PIT	600	900			225	43.208	44.81	1.60		CONSTRUCT NEW DRAINAGE PIT OVER EXISTING DRAINAGE
22	GRATED SIDE ENTRY PIT	600	900			300	42.876	44.34	1.46	EDCM 601/605	NISTALL
23	GRATED PIT	600	900			300	41.565	43.03	1.47	EDCM 605	INSTALL "BIKE SAFE" 600x900 ECO-WEAVED V-GRATE OR APPROVED EQUIVALENT & FRAME TO SUIT
24	GRATED SIDE ENTRY PIT	600	900	225	40.840	300	40.765	42.36	1.60	EDCM 601/605	EQUIVALENT CONTROL TO SOTT
24	GIVATED SIDE ENTITY FIT	000	300	300	40.815	300	40.703	42.50	1.00	EBOW 00 1/000	
25	JUNCTION PIT	600	900	300	70.013	225	41.374	42.80	1.43	EDCM 605	
										EDCM 601/605	
26	GRATED SIDE ENTRY PIT	600	900	200	20.005	300	40.900	42.37	1.47		DROVIDE TEMPORARY DIT COVER
27	GRATED SIDE ENTRY PIT	600	900	300	39.905	300	39.855	41.54	1.68	EDCM 601/605	PROVIDE TEMPORARY PIT COVER
	II INOTION DIT	000	000	300	39.905	200	40.000	44.00	4.54	EDOM 605	DDOVIDE TEMPORARY DIT COVER
28	JUNCTION PIT	600	900	300	40.439	300	40.389	41.93	1.54	EDCM 605	PROVIDE TEMPORARY PIT COVER
		000		225	40.464		44.000	40.45	0.55	EDOM COE	
33	JUNCTION PIT	600	900	225	41.710	225	41.660	42.49	0.83	EDCM 605	
34	JUNCTION PIT	600	900	225	43.051	225	43.001	43.77	0.77	EDCM 605	
35	JUNCTION PIT	600	900			225	43.977	44.71	0.73	EDCM 605	
37	JUNCTION PIT	600	900			225	41.225	41.97	0.74	EDCM 605	
38	JUNCTION PIT	600	900	300	37.922	300	37.872	39.53	1.66	EDCM 605	PROVIDE TEMPORARY PIT COVER
39	GRATED SIDE ENTRY PIT	600	900	300	38.420	300	38.370	40.12	1.75	EDCM 601/605	PROVIDE TEMPORARY PIT COVER
40	GRATED SIDE ENTRY PIT	600	900	300	38.640	300	38.590	40.13	1.54	EDCM 601/605	PROVIDE TEMPORARY PIT COVER
41	GRATED SIDE ENTRY PIT	600	900	225	40.283	300	40.208	41.90	1.69	EDCM 601/605	PROVIDE TEMPORARY PIT COVER
				300	40.258						
42	JUNCTION PIT	600	900			225	41.595	42.32	0.73	EDCM 605	
DC 4	II INICTION DIT	600(T)	900(T)	675	20.040	Ev4250	Ev24.00	25.07	4 74	EDCM 608	REFER PIT DETAILS ON SHEET 403. HAUNCH UNDER ROAD. PROVIDE
	JUNCTION PIT	500(1)	` '	675	32.916	Ex1350	Ex31.23	35.97	4.74		TEMPORARY PIT COVER
DS-4		1200(R)	1950/R)	750	20 570						
DS-4		1200(B)	1950(B)	750 750	32.570 31.830						

Approved By: Ange Dean

Planning Ref: PA21-0174

File No: SEng00300/22


Date: 19/04/2023 **Council Drawing No.:** R5956

Approval subject to:- A free draining out being available prior to Statement of Compliance.

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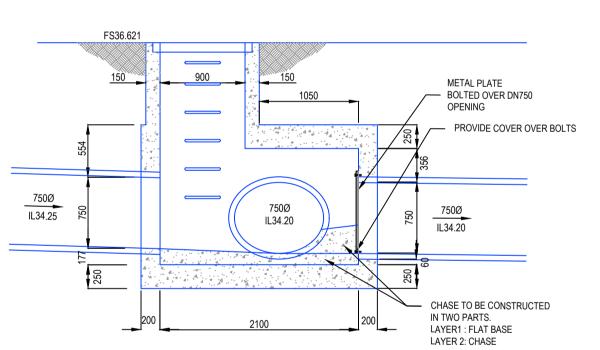
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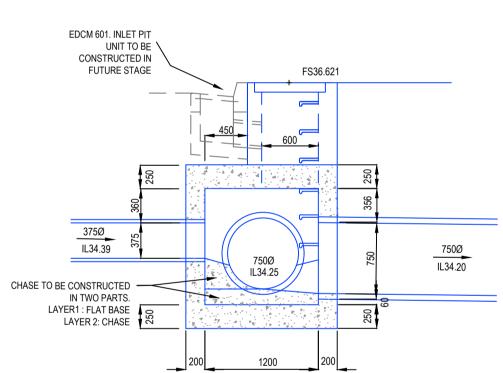
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PIT 3 DETAIL

SCALE 1:40 (A1)



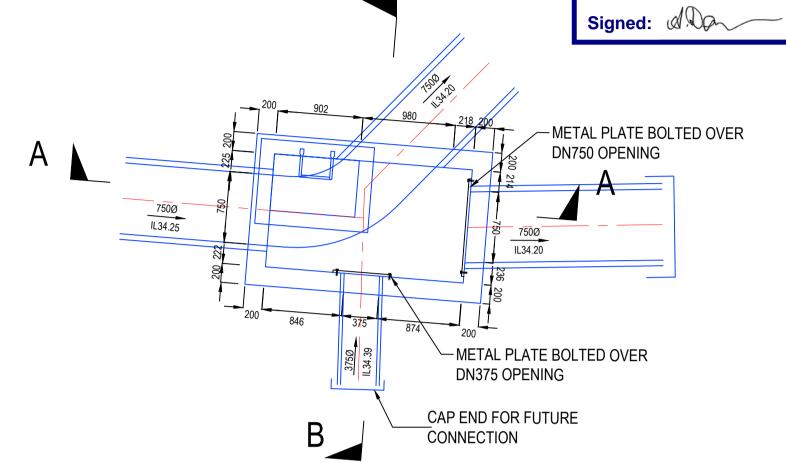

SECTION B-B

SCALE 1:40 (A1)

SECTION A-A

SCALE 1:40 (A1)

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Designed Date	C.DAWSON 28.10.2022		
Orawn	L.SUTHERLAND		Beveridge Williams
Checked	M.FELICIANO		_
Date	21.11.2022		
Approved	M.FELICIANO	Developme	nt and Infrastructure Consultants
Reg. No.	PE0005645	•	
Date	21.11.2022	1 Glenferrie Road	ph: 03 9524 8888
			·

Malvern VIC 3144

PS906797B

Project Details	MERIDIAN CENTRAL ESTATE STAGE 41	Sheet
	CITY OF CASEY	Scale
Drawing	PIT SCHEDULE	AS SHO
Title	AND PIT DETAILS	Project Ref
	7 (14D I II DEI 7 (1EO	4004707

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Drawing No

23 of 23

Stage No