MERIDIAN CENTRAL ESTATE - STAGE 34

BROWN PROPERTY GROUP CITY OF CASEY

CONSTRUCTION NOTES

SITE MANAGEMENT

- Prior to commencement of works on site, the contractor must ensure that all matters relating to the Occupational Health & Safety Act 2004, including all relevant regulations, have been addressed. In particular, the required notifications must be conveyed to the Victorian Workcover Authority - Health & Safety division with respect to trenching operations. Details of the contractors occupational health & safety procedures must be lodged with the superintendent prior to commencement of works
- A2 All native trees & shruhs to be retained unless road construction necessitates their removal or removal is directed by the engineer A town planning permit is required for the removal of native trees & I or vegetation. The removal or retention of any existing trees must be in accordance with the approved landscape plan, or else approval will be required from the City of Casey landscape
- A3. Existing dam or watercourses to be excavated to a firm base & backfilled as specified. Consulting engineer to be notified when the dam or watercourses are excavated to a firm base. No filling is to be placed prior to dams being inspected & levels taken. Backfilling is to be carried out to the satisfaction of the Council supervising engineer.
- Prior to commencement of works, the contractor must submit a Site Management Plan (SMP) to the consultant for approval. The contractor must comply with the recommendations of the Environment Protection Authority publication No.275 "Construction techniques for sediment pollution control". Appropriate sittation control is to be maintained throughout the construction &
- Provide temporary safety barrier fence (Farm Fence as per MW Std Dwg 7251/4/203) along extent of outfall drain where the drain is greater than 1.5m in depth & side slopes are steeper than 1 in 3. Safety fence to remain until permanent underground drainage is installed.
- Contractor to remove existing irrigation & drainage pipes & pits encountered on site. Trenches to be backfilled in accordance with notes C2 & C3.
- An environmental management plan (EMP) must be submitted to and approved by Council prior to the commencement of any works on site and all works must be carried out in accordance with this EMP.
- A8. A traffic management plan (TMP) must be submitted to, and approved by Council prior to the commencement of any works on site

- All works to be carried out in accordance with AS2124-1992 general conditions of contract & the City of Casey and EDCM current
- B2. Council to be notified two (2) clear days prior to commencement of works.
- B3. Before commencement of works on trenches in excess of 1.5m deep, the civil contractors construction supervisor must give notice in writing of such proposals to Worksafe Victoria in accordance with Part 5.1, Division 4 of the Occupational Health & Safety regulations (2007) & undertake safety precautions in trenching operations in accordance with Workcover's code of practice (1988).
- Lots to be graded (1 in 150 min slope) & left clean to the satisfaction of the engineer. Finished levels to be compatible with lots
- On completion the contractor is responsible for the removal of all rubbish & spoil from site. No surplus trees, vegetation or other material is to be burnt on site.
- Reserves to be free draining & to be left in a condition satisfactory to the City of Casey works supervisor.
- Where works are in the vicinity of existing services these services are to be located & the various authorities notified prior to the
- All TBM's & control points are to be maintained & protected at all times during construction. Should any marks be disturbed, the contractor will immediately notify the consultant to arrange re-instatement at the contractors expense
- B9. Provide painted paling fence along any boundary common to lots & municipal reserves as per Council Std. Dwg. S-706. Palings to
- B10. As constructed plans and electronic asset information in D-Spec and R-Spec format must be submitted to Council prior to practical

ROADWORKS

- 100a agricultural pipe drains (MPA standard drawing EDCM 202) to be placed behind all kerb & channel & buffer pitchers & where directed by the engineer.
- C2. Filling in all properties & road reserves is to be carried out using approved clay fill. Top soil & all vegetable matter to be stripped from site prior to filling. All filling to be carried out in accordance with AS3798-2007 and the geotechnical report. Level 1 inspection and testing to be carried out in accordance with AS3798-2007 Section 8.2. A fill report must be submitted to the Consultant, showing from a NATA registered soil testing laboratory.
- Importing Fill: All imported fill must be tested by a NATA approved laboratory to ensure it is suitable for use on site, & any contaminates are within accepted levels. Under no circumstances should fill material enter or leave the site without the permission of the supervising engineer & Council works supervisor, prior to it being appropriately tested. All vehicles transporting fill material to & from the site must have appropriate measures in place to ensure that material does not get onto roads & into stormwater
- C4 Ratters to be 1 in 5 for fill & 1 in 3 for cut unless noted otherwise
- Cut batters are to be grassed & mulched with a mixture of chopped grass, straw & bitumen emulsion.
- C6. Where cut batters exceed 700mm an additional 300mm berm shall be formed behind footpath

- Access ramps are to be constructed where cut batters exceed 1.0m. They are to be graded 1 in 10 for the first 2.5m from the back of path & then at a maximum of 1 in 4 to natural surface.
- The water conduit offset from the lot boundary is given on the water reticulation plan. The contractor must construct conduits to accord with the given offset & ensure that the concreter marks the kerb & footpath exactly above the conduit.
- Irrigation conduits are to be DN100 DWV PVC installed beneath the pavement and/or capping layer, if present. Locations are to be marked using a green dot spray painted on the top of kerb.
- C10. All footpaths are to be 125mm thick 25MPa concrete with SL72 mesh centrally located in accordance with the MPA standard drawing EDCM 401.
- C11. NBN Co to be notified seven (7) days prior to concrete works being placed.
- C12. Electrical distribution pits within footpaths are to be a minimum of 300mm within the edge of the path. Concrete is to be placed around distribution pits to a minimum depth of 200mm
- C13. All street signs to be constructed & erected to current City of Casey standards including logo. Court street names are to show
- C14. Traffic control signs, markings & delineators to be installed in accordance with AS1742.2. All line marking is to be long life road marking, with longitudinal lines in thermoplastic & transverse markings in cold applied.
- C15. Driveways to be constructed in accordance with the MPA standard drawings EDCM 501 & EDCM 502. Single driveways to be a minimum 3.5m wide & to be offset 0.75m from side boundary or easement unless otherwise shown
- C17. Existing road works to be reconstructed as required to provide, without discontinuity, a connection in accordance with design
- C18. Provide 2.5m wide shared footpath through reserves as shown on a curvilinear alignment to the satisfaction of the engineer.
- C19. Tactile ground surface indicators (TGSI) are to be installed at all pram crossings & pedestrian cross points in accordance with
- compacted to Council requirements. A geo-technical report must be submitted showing details of depth, type of material and density of the fill areas concerned.


- D1. Drainage & pits to be set out from offsets shown rather than from centreline pipe chainages. Centreline of pits at TP's to be offset 1.00m.
- D2. Terra Firma or fibreglass type pit lids are required for all drainage pits & all grates for pits are to be Class D, to comply with AS3996 unless otherwise shown. All drainage works are to be constructed to council specifications.
- D3. All pipes up to and including 750mm in diameter shall be rubber ring jointed (RRJ). Pipes above this size may be flush jointed with external sealing bands. For pipes greater than 900mm and changes in direction between 2 connecting pipes exceeding 10° construct segmented curves using splayed pipes with bandage joints, having deflections within the manufacturer's specification.
- D4. All pipes to be Class '2' R.C. rubber ring joint unless noted otherwise. PVC pipes to be Class SH unless specified.
- Pipe trenches beneath the road pavement, footpath or within 150mm of the kerb & channel to be backfilled with 20mm Class 3
- D6. Property inlets to be constructed as per MPA standard drawing EDCM 701 EDCM 704
- D7. All proposed drainage stubs to be blanked off at end of pipe with timber planks to the satisfaction of the supervising engineer
- D8. A CCTV report must be provided for all drainage lines prior to issue of practical completion

PAVEMENT

Modification of the pavement requires approval by the City of Casey works supervisor.

DRAWING INDEX

DRAWING No.	TITLE	REVISION
1801767-34-001	COVER SHEET	С
1801767-34-002	TYPICAL ROAD CROSS SECTIONS & GENERAL DETAILS	Α
1801767-34-003	PAVEMENT MAKEUP & RETAINING WALL DETAILS	Α
1801767-34-010	LAYOUT PLAN (SHEET 1 OF 2)	Α
1801767-34-011	LAYOUT PLAN (SHEET 2 OF 2)	В
1801767-34-100	ROAD LONGITUDINAL SECTIONS - TARANAKI CIRCUIT (SHEET 1 OF 2)	А
1801767-34-101	ROAD LONGITUDINAL SECTIONS - TARANAKI CIRCUIT (SHEET 2 OF 2) & RESERVE No.3 FOOTPATH	Α
1801767-34-200	ROAD CROSS SECTIONS - TARANAKI CIRCUIT (SHEET 1 OF 3)	А
1801767-34-201	ROAD CROSS SECTIONS - TARANAKI CIRCUIT (SHEET 2 OF 3)	Α
1801767-34-202	ROAD CROSS SECTIONS - TARANAKI CIRCUIT (SHEET 3 OF 3)	А
1801767-34-203	FOOTPATH CROSS SECTIONS	А
1801767-34-300	INTERSECTION DETAILS	А
1801767-34-350	SIGNAGE & LINE MARKING PLANS	Α
1801767-34-400	DRAINAGE LONGITUDINAL SECTIONS (SHEET 1 OF 4)	Α
1801767-34-401	DRAINAGE LONGITUDINAL SECTIONS (SHEET 2 OF 4)	A
1801767-34-402	DRAINAGE LONGITUDINAL SECTIONS (SHEET 3 OF 4)	А
1801767-34-403	DRAINAGE LONGITUDINAL SECTIONS (SHEET 4 OF 4) AND PIT SCHEDULE	В

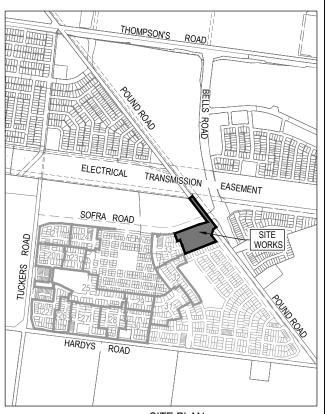

SITE PLAN NOT TO SCALE

MELWAY REF: 135 F4

Coordinates are on a local plane datum based upon MGA2020 Zone 55 bearings and truncated MGA2020 Zone 55 co-ordinates at PM77. Heights are to AHD vide Permanent Mark PM 56 (Cranbourne) RL 26.7 Bearing Datum is MGA2020 Zone 55 which has been derived by our GPSnet Survey.

Plane Grid Coordinates to MGA2020 Zone 55 Grid Coordinates

(PLANE SHIFT)

(APPLY SCALE FACTOR)

Add + 353,823.586 to Eastings Add +5,780,840.520 to Northings Scale by 0.999846 at point PM77

> ISSUED FOR CONSTRUCTION

A ISSUED FOR CONSTRUCTION 23.08.22 E.B M.F DATE DRN. APP. REV













Project Details MERIDIAN CENTRAL ESTATE Sheet 01 of 17 STAGE 34 CITY OF CASEY Drawing COVER SHEET 1801767 34 001

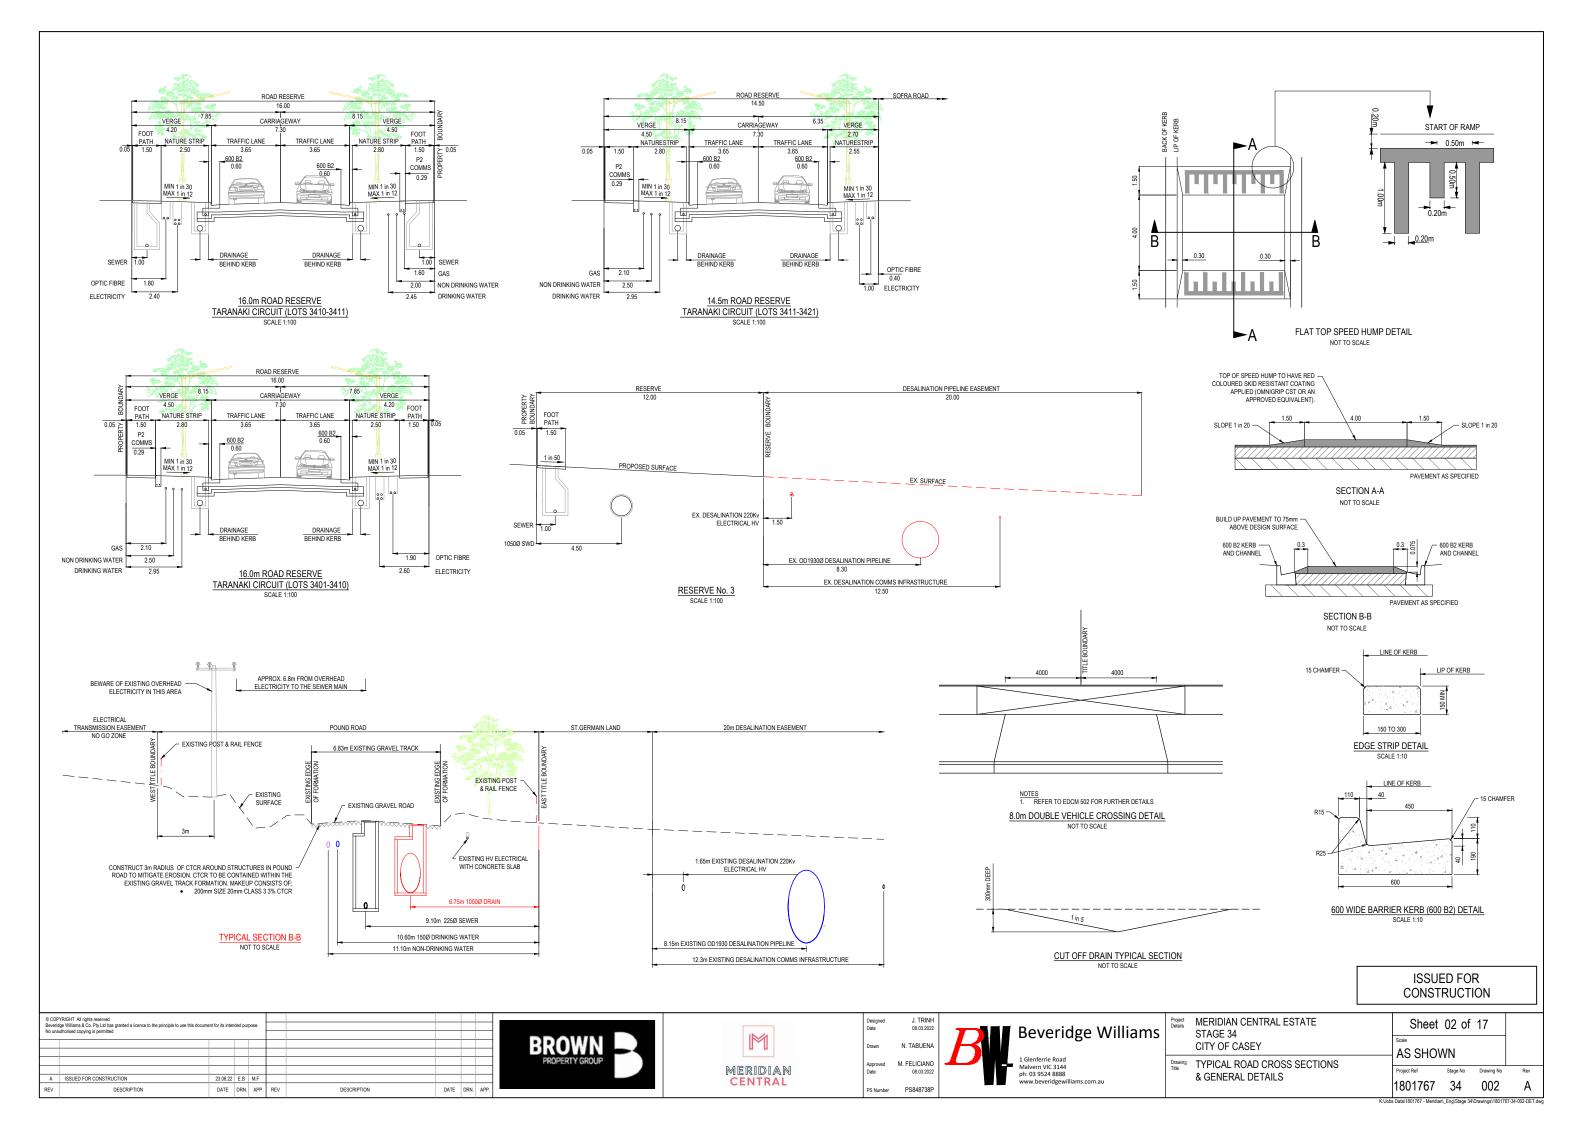

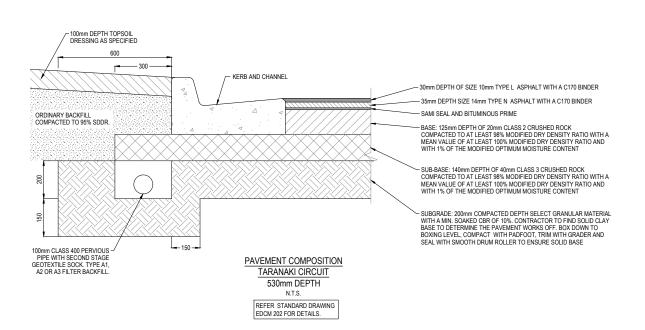

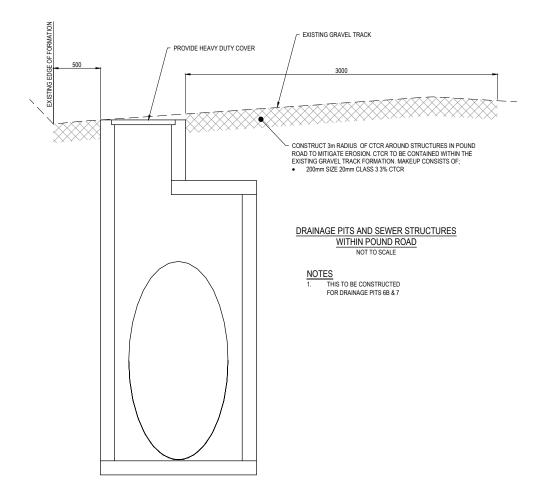


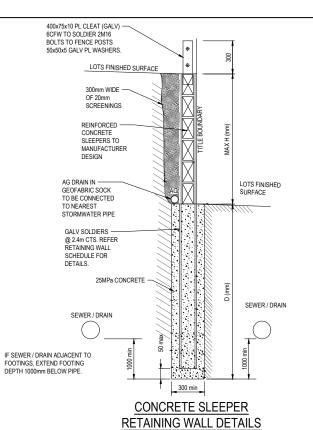

CONCRETE SLEEPER RETAINING WALL SCHEDULE										
HEIGHT - H(mm) DEPTH - D(mm) SOLDIERS SIZE @ 2.4m CTS										
600	900	100 UC 14.8								
800	1200	100 UC 14.8								
1000	1500	100 UC 14.8								

NTS

Dmin TO BE GREATER OF THAT SHOWN ABOVE OR 1000mm BELOW ADJACENT SEWER / FRAINAGE

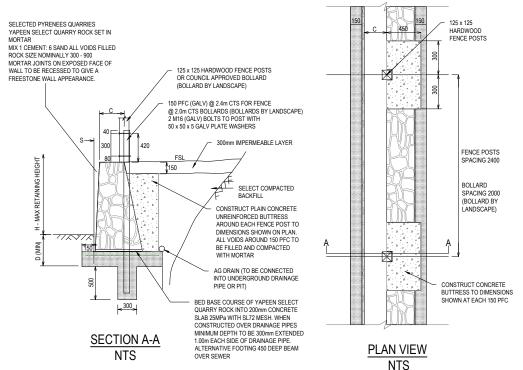

SELECTED PYRENEES QUARRIES YAPEEN SELECT QUARRY ROCK SET IN MORTAR MIX 1 CEMENT: 6 SAND ALL VOIDS FILLED ROCK SIZE NOMINALLY 300 - 900 300mm IMPERMEABLE LAYER MORTAR JOINTS ON EXPOSED FACE OF WALL TO BE RECESSED TO GIVE A FREESTONE WALL APPEARANCE. SELECT COMPACTED BACKFILL 20mm SCREENINGS BACKEILL 300mm WIDTH PLACED AGAINST BACK OF WALL SURROUNDED WITH GEOFABRIC AG DRAIN (TO BE CONNECTED INTO BED BASE COURSE OF YAPEEN SELECT QUARRY ROCK INTO 200mm CONCRETE SLAB 25MPa WITH SL72 MESH. WHEN CONSTRUCTED OVER DRAINAGE PIPES B MIN MINIMUM DEPTH TO BE 300mm EXTENDED 1.00m EACH SIDE OF DRAINAGE PIPE. MASS ROCK RETAINING ALTERNATIVE FOOTING 450 DEEP BEAM OVER SEWER

WALL DETAIL (TYPE RR)

NTS

MASS	MASS ROCK RETAINING WALL SCHEDULE													
MAX WALL HEIGHT-H(mm)	FOUNDING DEPTH-D(mm)	BASE WIDTH - B(mm)	FRONT FACE SETBACK-S (mm)	CREST WIDTH-C(mm)										
400	400	450	15	300										
500	400	500	15	300										
600	400	500	30	300										
800	400	600	30	300										
1000	400	700	30	300										

RETAINING WALL NOTE R.1

a. WHERE FOOTPATH ABUTS RETAINING WALL CONTINUE CONCRETE UP TO BASE OF

- FOOTING NOTE F.2.

 a. TOE OF WALL SHALL PENETRATE THROUGH ANY FILL MATERIAL & THE NATURAL SILT SOLLS TO BE FOUNDED AT LEAST 100mm INTO THIS UNDERLYING NATURAL STILL CLAY OR WEATHERED ROCK.
 - ALL EXCAVATIONS SHALL HAVE FOUNDING DEPTHS AND BEARING
- ALL EXCAVATIONS SHALL HAVE FOUNDING DEPTHS AND BEARING
 CAPACITY APPROVED BY THE ENGINEER OR BUILDING SURVEYOR
 BEFORE CONCRETE IS PLACED.
 FOOTING EXCAVATIONS WHICH ARE DEEPEND TO PENETRATE
 THROUGH UNSUITABLE SOILS SHALL BE BACKFILLED UP TO UNDERSIDE OF FOOTINGS
 WITH 15 MPa BLINDING CONCRETE.
 b. ALL EXCAVATION FOUNDING SURFACES SHALL BE LEVEL (NOT INCLINED) CLEAN CUT &
 EDEE OF MILL DO MAGED.
- FREE OF MUD OR WATER.
- c. ALL SEEPAGE INFLOW SHALL BE REMOVED BEFORE PLACEMENT OF CONCRETE

d. FOOTINGS SHALL BE FOUNDED IN STIFF NATURAL CLAY HAVING A SAFE BEARING

MASS ROCK RETAINING WALL DETAIL WITH PALING TIMBER FENCE (TYPE RR) OR BOLLARD (BOLLARD BY LANDSCAPE)

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23.08.22 E.B M.F DATE DRN. APP. REV







Designed Date	J. TRINH 08.03.2022
Drawn	N. TABUENA
Approved Date	M. FELICIANO 08.03.2022
PS Number	PS848738P



Dra	Project Details	MERIDIAN CENTRAL ESTATE STAGE 34	Sheet 03 of 17	
		CITY OF CASEY	AS SHOWN	
	Drawing Title	PAVEMENT MAKEUP	Project Ref Stage No Drawing No	
		& RETAINING WALL DETAILS	1801767 34 003	

Α

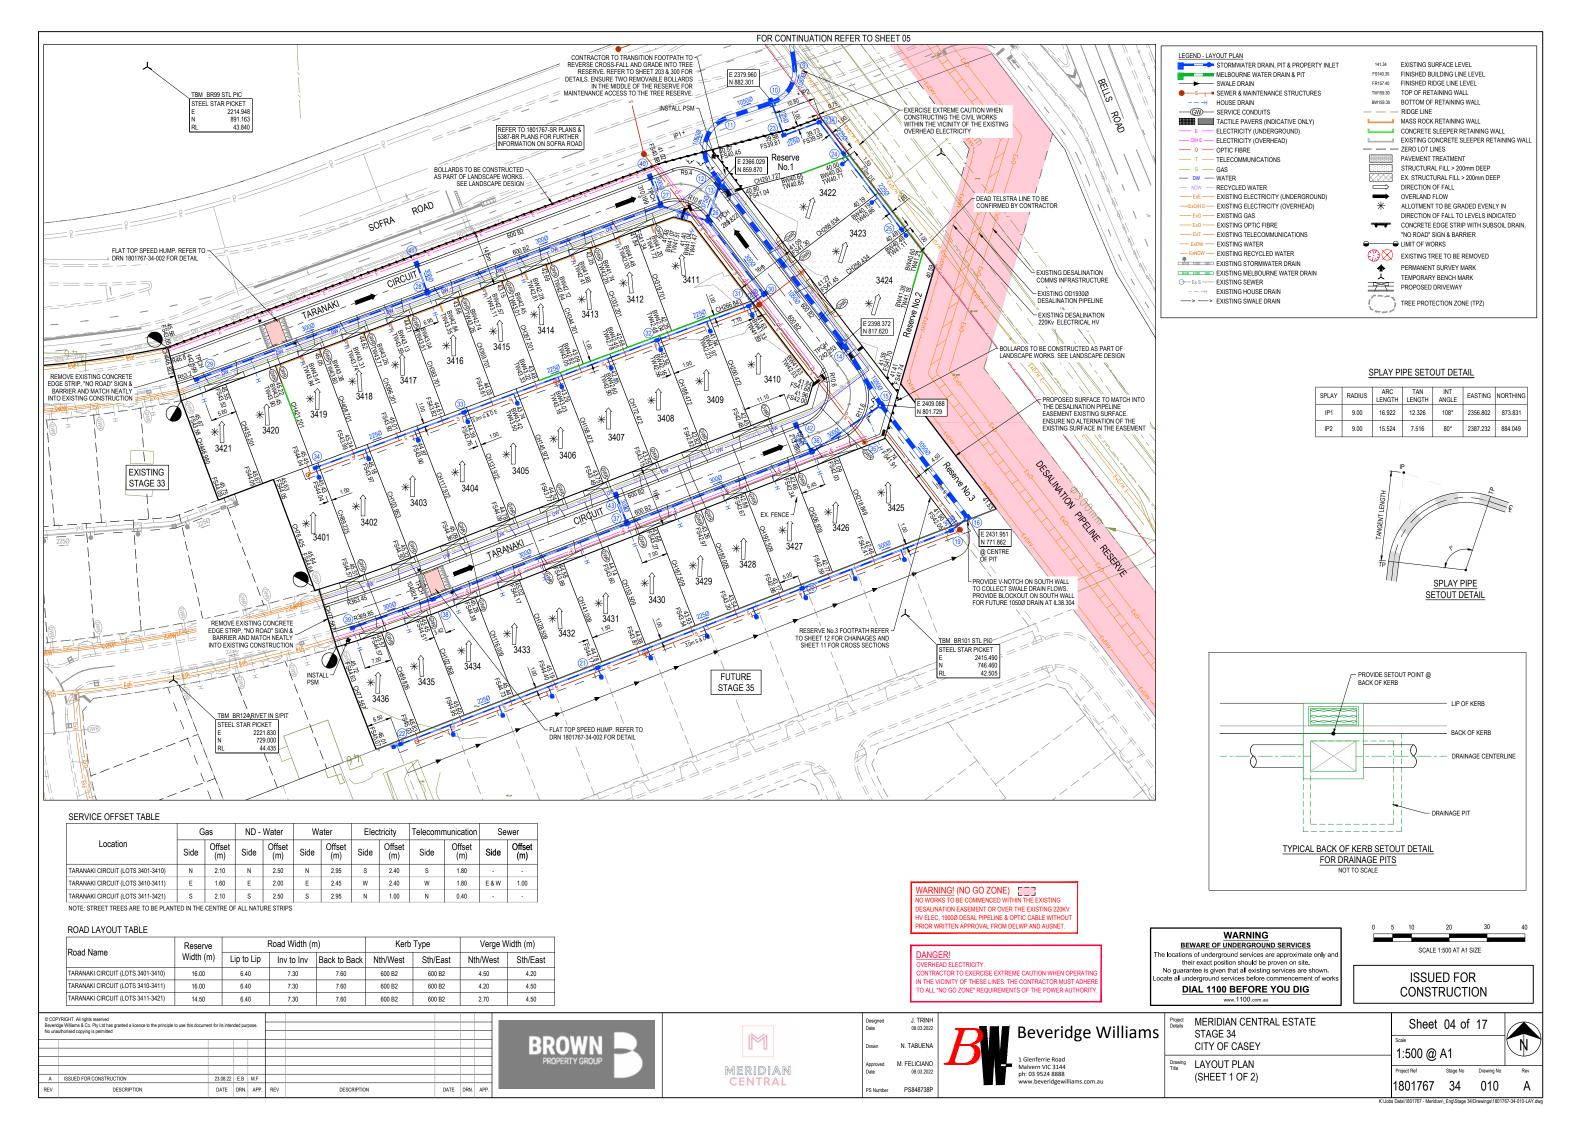

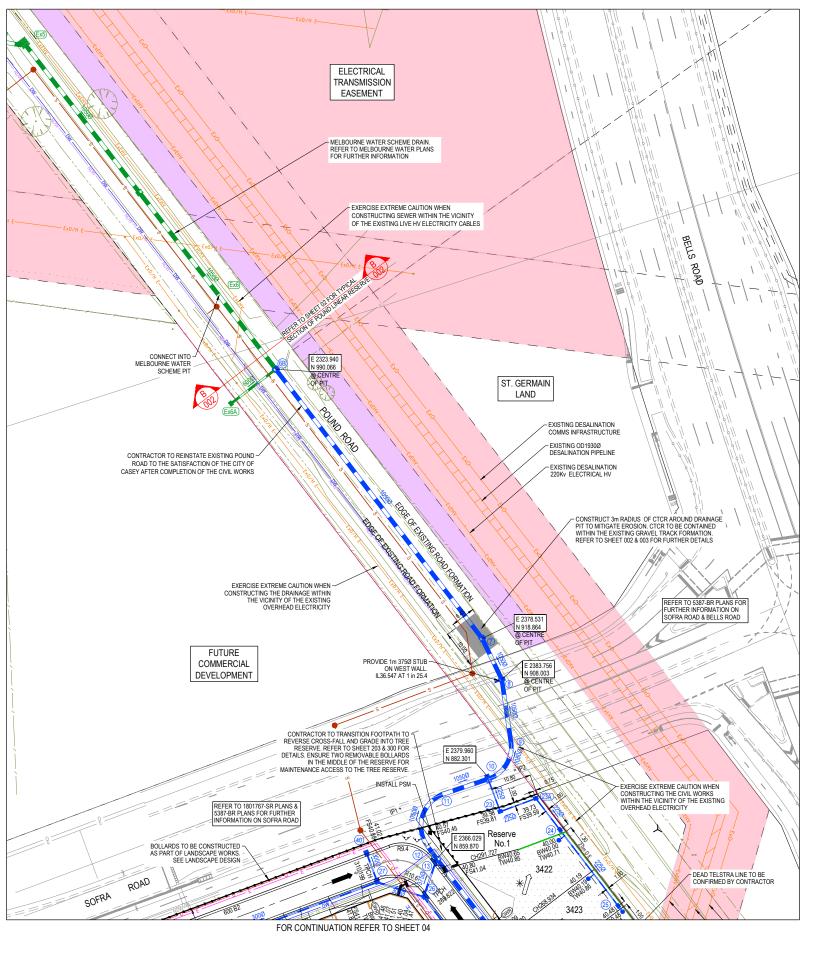

LEGEND - LAYOUT PLAN

STORMWATER DRAIN, PIT & PROPERTY INLET

MELBOURNE WATER DRAIN & PIT

SWALE DRAIN ● S SEWER & MAINTENANCE STRUCTURES H HOUSE DRAIN SERVICE CONDUITS

TACTILE PAVERS (INDICATIVE ONLY) ELECTRICITY (UNDERGROUND) - ELECTRICITY (OVERHEAD) OPTIC FIBRE - T - TELECOMMUNICATIONS — DW — WATER
— NDW — RECYCL RECYCLED WATER --- EXE --- EXISTING ELECTRICITY (UNDERGROUND) —EXO/H E— EXISTING ELECTRICITY (OVERHEAD) ---- EXG ---- FXISTING GAS EXISTING OPTIC FIBRE --- EXT --- EXISTING TELECOMMUNICATIONS - EXDW - EXISTING WATER EXNOW — EXISTING RECYCLED WATER EXISTING STORMWATER DRAIN EXISTING MELBOURNE WATER DRAIN → Ex S — EXISTING SEWER EXISTING HOUSE DRAIN ---> ----> EXISTING SWALE DRAIN 141.34 EXISTING SURFACE LEVEL FS140.35 FINISHED BUILDING LINE LEVEL FR157.40 FINISHED RIDGE LINE LEVEL TW159.30 TOP OF RETAINING WALL BW159.30 BOTTOM OF RETAINING WALL — — RIDGE LINE MASS ROCK RETAINING WALL CONCRETE SLEEPER RETAINING WALL
EXISTING CONCRETE SLEEPER RETAINING WALL — — ZERO LOT LINES PAVEMENT TREATMENT STRUCTURAL FILL > 200mm DEEP
EX. STRUCTURAL FILL > 200mm DEEP DIRECTION OF FALL

OVERLAND FLOW

ALLOTMENT TO 27 ALLOTMENT TO BE GRADED EVENLY IN DIRECTION OF FALL TO LEVELS INDICATED CONCRETE EDGE STRIP WITH SUBSOIL DRAIN, "NO ROAD" SIGN & BARRIER ← LIMIT OF WORKS EXISTING TREE TO BE REMOVED PERMANENT SURVEY MARK **★** TEMPORARY BENCH MARK
PROPOSED DRIVEWAY TREE PROTECTION ZONE (TPZ)

ST.GERMAIN LAND

WARNING! (NO GO ZONE)

NO WORKS TO BE COMMENCED WITHIN THE EXISTING
DESALINATION EASEMENT OR OVER THE EXISTING 220KV
HV ELEC, 1900/0 DESAL PIPELINE & OPTIC CABLE WITHOUT
DEPOCHAPTION PROPERLY RECORD FILE WAS AN ADMINISTRA

VERHEAR ELECTRICIT

OVERHEAD ELECTRICITY.
CONTRACTOR TO EXERCISE EXTREME CAUTION WHEN OPERATIN
IN THE VICINITY OF THESE LINES. THE CONTRACTOR MUST ADHER
TO ALL "NO GO ZONE" REQUIREMENTS OF THE POWER AUTHORIT

WARNING BEWARE OF UNDERGROUND SERVICES

The locations of underground services are approximate only and their exact position should be proven on site. No guarantee is given that all existing services are shown. Locate all underground services before commencement of works DIAL 1100 BEFORE YOU DIG

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SCALE 1:500 AT A1 SIZE

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B CTCR EXTENDED DOWNSTREAM OF PIT 7 0.86.95 22 C.D. M.F.

A ISSUED FOR CONSTRUCTION 22.08.22 E.B. M.F.

REV DESCRIPTION DATE DRN. APP. REV DESCRIPTION DATE DRN. APP.









5	Project Details	MERIDIAN CENTRAL ESTATI STAGE 34 CITY OF CASEY
	Drawing Title	LAYOUT PLAN

(SHEET 2 OF 2)

Sheet 05 of 17

Scale
1:500 @ A1

1801767 34 011 B

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LEGEND


EXISTING SURFACE

DESIGN LINE

FUTURE DESIGN LINE
EXISTING SURFACE AT
SOUTH / WEST BOUNDARY

SOUTH / WEST LIP OF KERB
EXISTING SURFACE AT
NORTH / EAST BOUNDARY


NORTH / EAST BOUNDARY

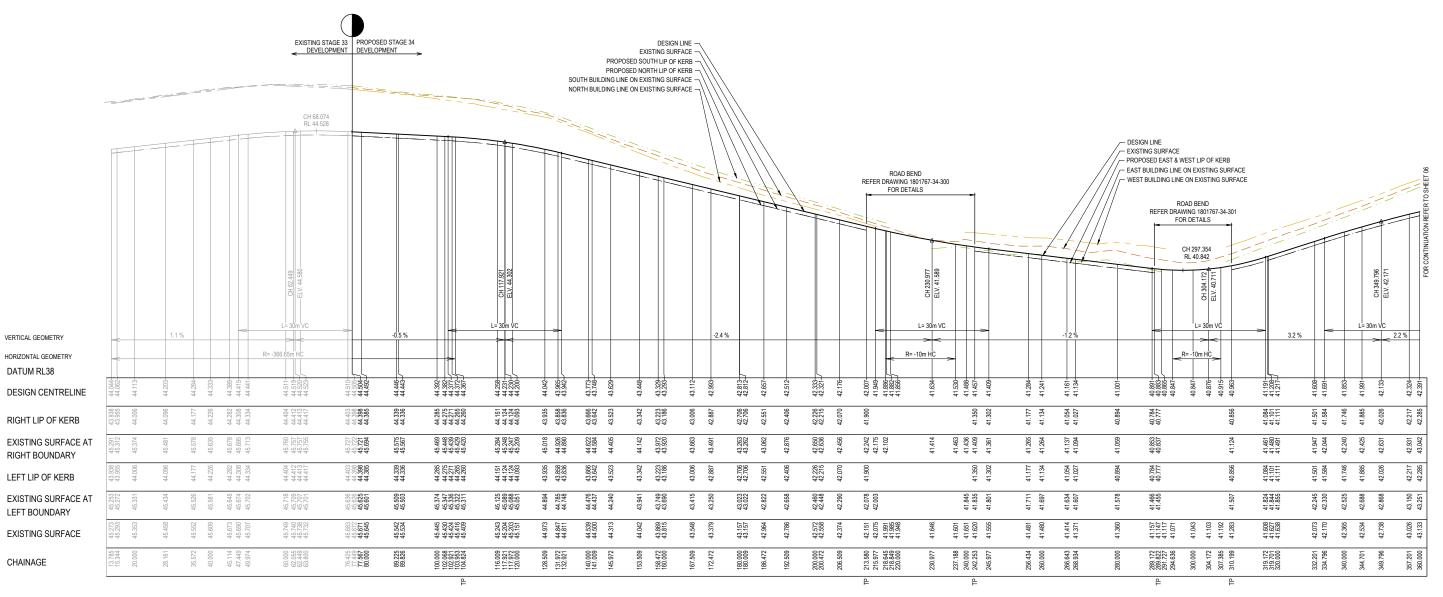

TARANAKI CIRCUIT - ROAD LONGITUDINAL SECTION

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BROWN 158UED FOR CONSTRUCTION 22.08.22 E.B. M.F. 22.08.22 E.B. M.F.	© COPYRIGHT All rights reserved Beveridge Williams & Co. Pty Ltd has granted a licence to the principle to use this document for its intended purpose. No unauthorised copying its permitted					HORIZONTAL	Designe Date	J. TRIN 08.03.202	H 22	Beveridge Williams	Project Details MERIDIAN CENTRAL ESTATE STAGE 34	Sheet 06 of 17
		REV	DESCRIPTION DA	NATE DRN. APP.	0 5 10 0 0.5 1	20 30 L L 2 3	4 5 Approve	M. FELICIAN 08.03.202		1 Glenferrie Road Malvern VIC 3144 ph: 03 9524 8888	CITY OF CASEY Drawing ROAD LONGITUDINAL SECTIONS	Project Ref Stage No Drawing No Rev

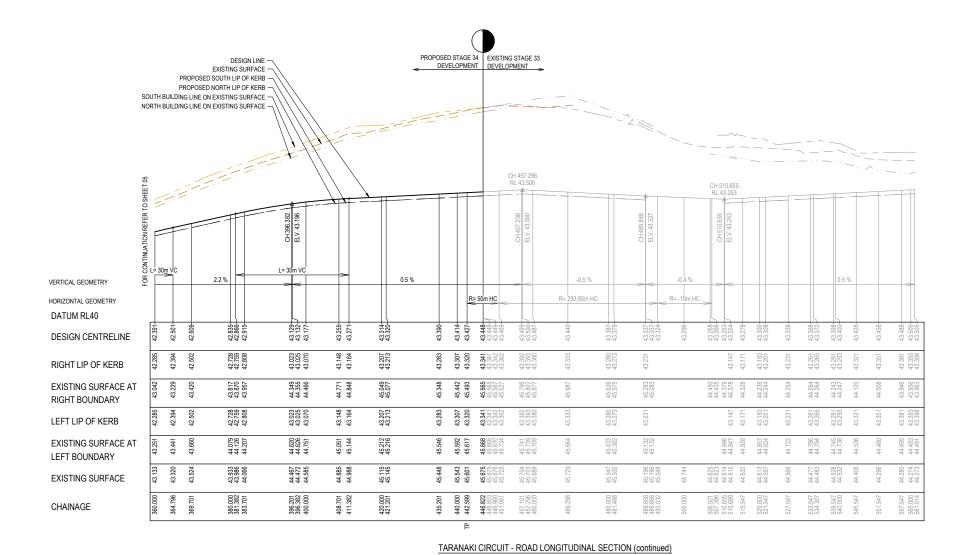

VERTICAL GEOMETRY
HORIZONTAL GEOMETRY
DATUM RL39

DESIGN CENTRELINE


EXISTING SURFACE


SUBSTING SUBSTINCT SUBSTING SUBSTING SUBSTING SUBSTING SUBSTING SUBSTING SUBSTINCT SUBSTING SUBSTINCT SUBSTING SUBSTINCT SUBSTING SUBSTINCT S

RESERVE No.3 FOOTPATH - LONGITUDINAL SECTION

ISSUED FOR CONSTRUCTION

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				BROWN PROPERTY GROUP	0 5 10 20	30 40	50 Drawn 5 Approved	M. FELICIANO	1 Glenferrie Road	Drawing ROAD LONGITUDINAL SECTIONS	1:500 H 1:50 V @ A1
A ISSUED FOR CONSTRUCTION 23.08.22 I	B M.F			CENTRAL	VE	RTICAL	Date	08.03.2022	Malvern VIC 3144 ph: 03 9524 8888 www.beveridgewilliams.com.au	TARANAKI CIRCUIT (SHEET 2 OF 2)	Project Ref Stage No Drawing No Rev
REV DESCRIPTION DATE D	RN. APP. REV	DESCRIPTION	DATE DRN. APP.				PS Number	PS848738P		& RESERVE No.3 FOOTPATH	1801767 34 101 A

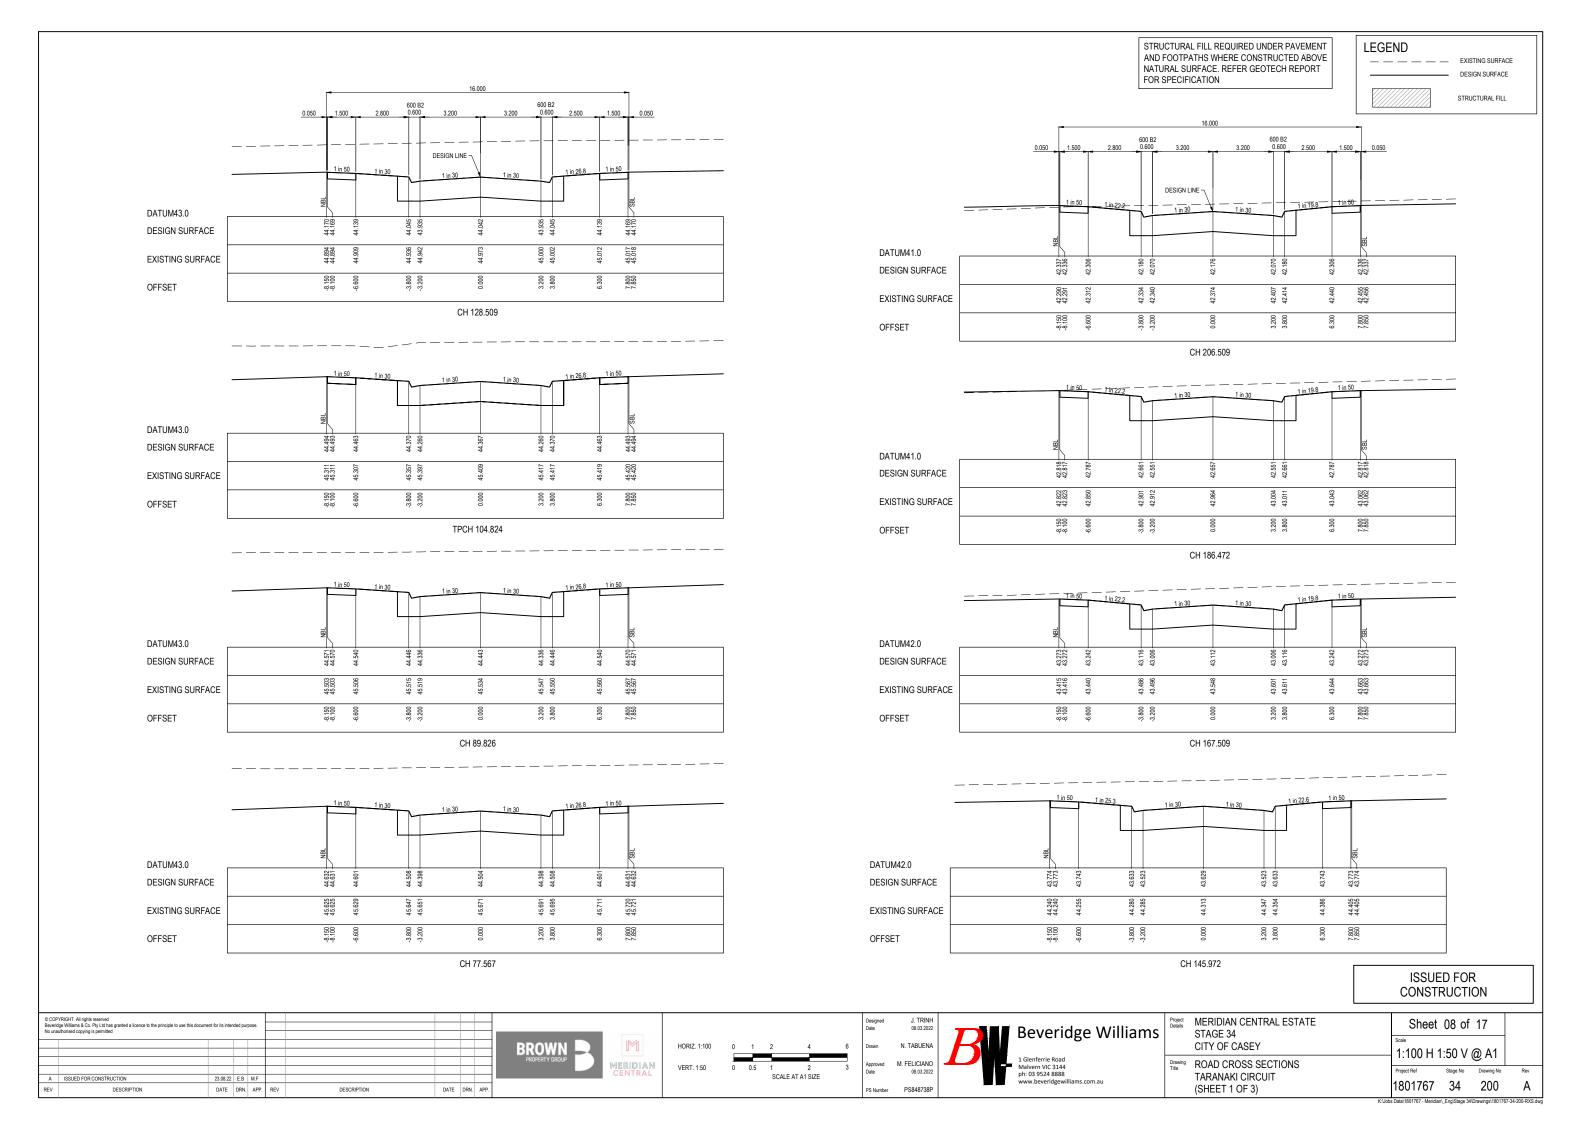

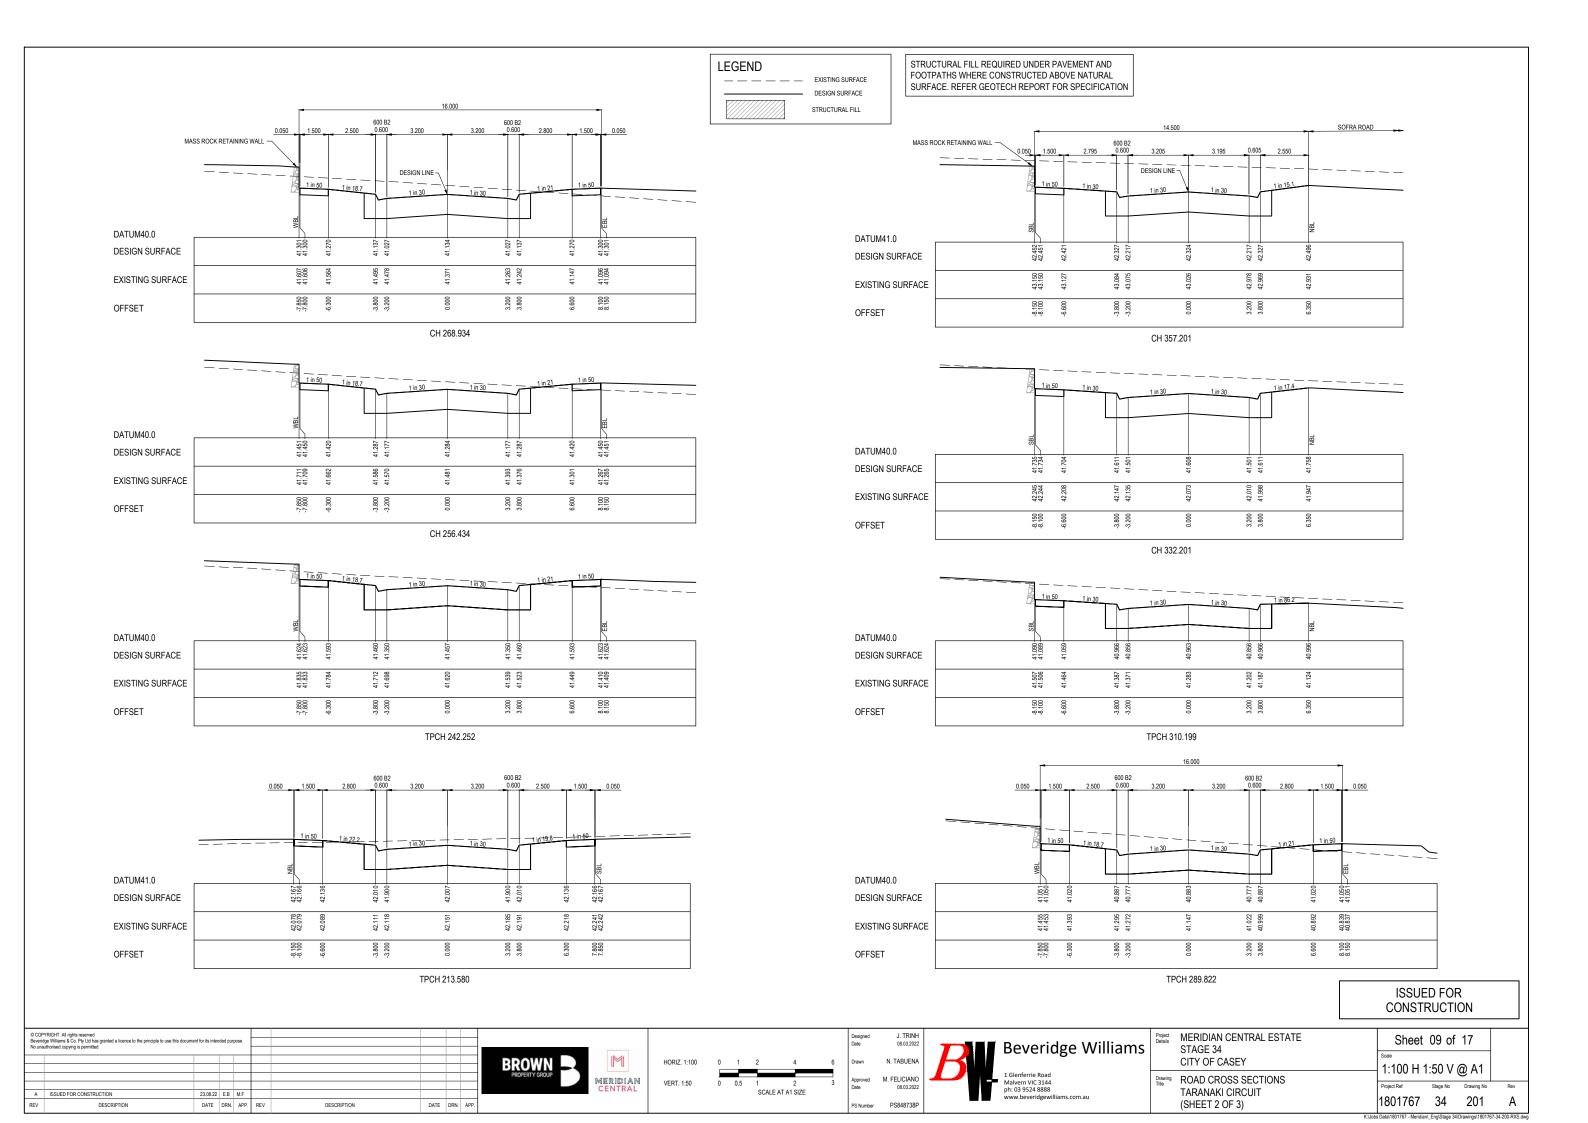

SOFRA ROAD MASS ROCK RETAINING WALL -DESIGN LINE ¬ DATUM42.0 43.446 DESIGN SURFACE SOFRA ROAD 45.216 45.214 EXISTING SURFACE 8.150 8.100 6.600 -3.800 3.200 OFFSET CH 421.201 DESIGN LINE ¬ DATUM42.0 43.575 43.574 DESIGN SURFACE 45.667 45.666 45.625 45.607 EXISTING SURFACE -8.150 -8.100 3.800 DATUM42.0 OFFSET DESIGN SURFACE CH 446.822 45.051 EXISTING SURFACE 8.150 8.100 6.600 OFFSET CH 408.701 DATUM42.0 DATUM42.0 43.043 DESIGN SURFACE DESIGN SURFACE EXISTING SURFACE EXISTING SURFACE 8.150 -8.100 -6.600 -8.150 -8.100 -6.600 -3.800 3.200 3.800 3.200 OFFSET OFFSET CH 383.701 TPCH 442.599 ISSUED FOR CONSTRUCTION Project Details MERIDIAN CENTRAL ESTATE Sheet 10 of 17 Beveridge Williams STAGE 34 M CITY OF CASEY N. TABUENA HORIZ. 1:100 1:100 H 1:50 V @ A1 Drawing ROAD CROSS SECTIONS MERIDIAN CENTRAL M. FELICIANO VERT. 1:50 Project Ref Stage No Drawing No SCALE AT A1 SIZE TARANAKI CIRCUIT 23.08.22 E.B M.F A ISSUED FOR CONSTRUCTION 1801767 34 202 DESCRIPTION DATE DRN. APP. REV DATE DRN. APP. (SHEET 3 OF 3)


STRUCTURAL FILL REQUIRED UNDER PAVEMENT


AND FOOTPATHS WHERE CONSTRUCTED ABOVE NATURAL SURFACE. REFER GEOTECH REPORT


FOR SPECIFICATION

LEGEND

STRUCTURAL FILL

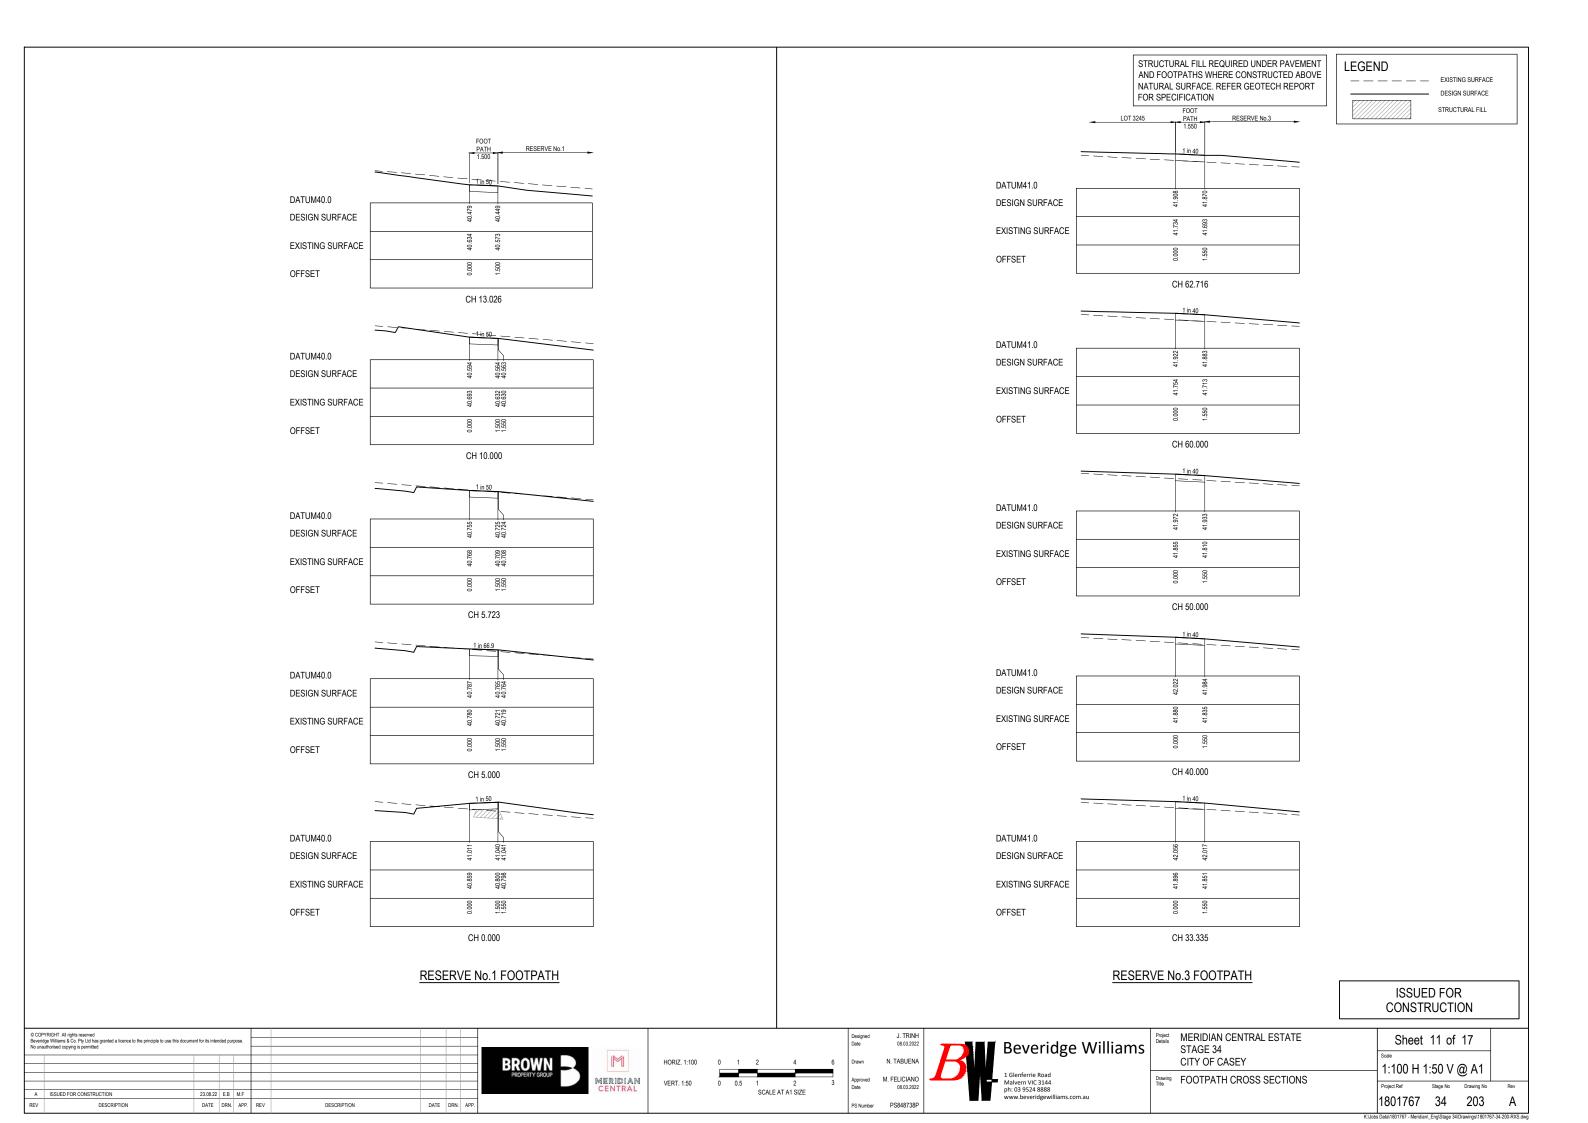

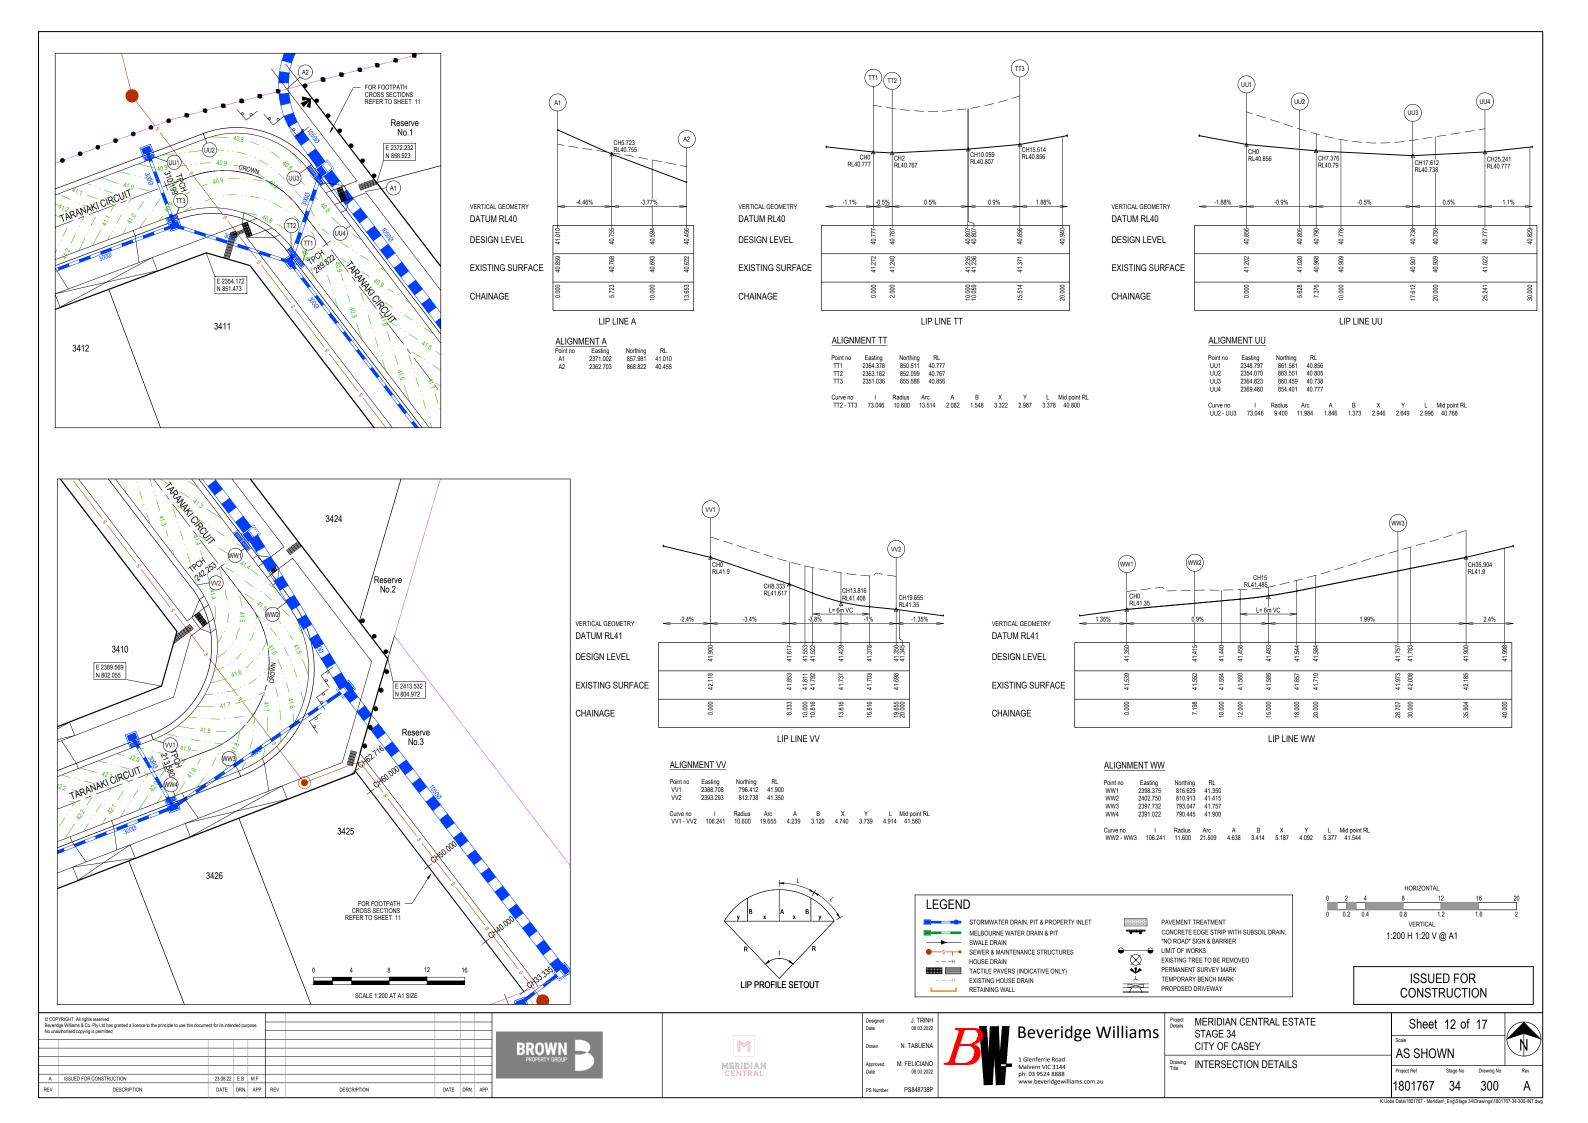

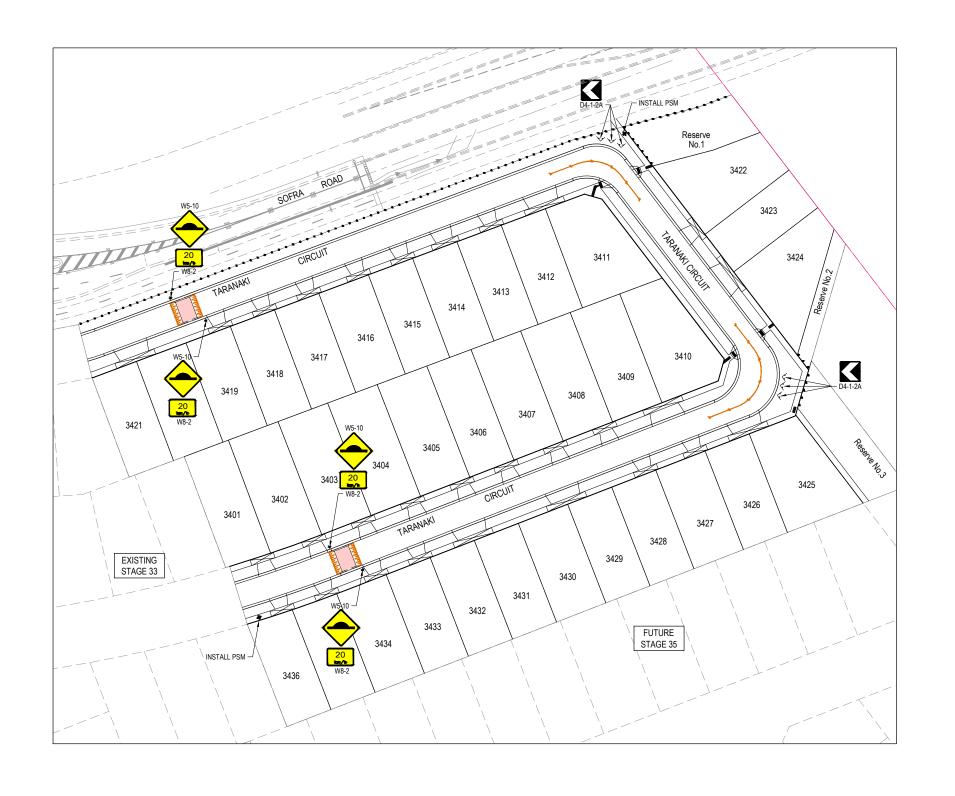

NOTES

- 1. RRPM'S AT MAX 6m SPACING.
- 2. LINEMARKING TO BE EXTENDED AT LEAST 6m FROM THE TANGENT POINT
- 3. LINEMARKING IN ACCORDANCE WITH AS1742.4. TGSI TO BE INSTALLED IN ACCORDANCE WITH
- VICROADS RDN 06-06 JULY 2010
 5. ALL STREET NAME SIGNS AT INTERSECTIONS TO
- include relevent street numbering.
- ALL LINE MARKING PAINT SHALL BE LONG LIFE
 TYPE. LATERAL WORKS AND ARROWS BEING COLD
 APPLIED PLASTIC TROWELLED INTO PLACE
 (MATERIAL DEGADUR PLASTELINE) AND
 LONGITUDINAL LINES BEING EXTRUDED
 THERMOPLASTIC MATERIAL.


ISSUED FOR CONSTRUCTION

Project Details MERIDIAN CENTRAL ESTATE J. TRINH 08.03.2022 Sheet 13 of 17 Beveridge Williams STAGE 34 N. TABUENA CITY OF CASEY BROWN 1:500 @ A1 M. FELICIANO 08.03.2022 Drawing Title SIGNAGE & LINE MARKING PLANS MERIDIAN CENTRAL SCALE 1:500 AT A1 SIZE A ISSUED FOR CONSTRUCTION 23.08.22 E.B M.F 1801767 34 350 Α DATE DRN. APP. REV bs Data\1801767 - Meridian_Eng\Stage 34\Drawings\1801767-34-350-LMP.dw

NOTES:
ALL STORMWATER DRAINS UP TO AND INCLUDING 750mm DIA. ARE TO BE CLASS 2 R.R.J. PIPES UNLESS NOTED OTHERWISE.

LEGEND

EXISTING SURFACE
DRAINAGE PIPEIPIT
EXISTING DRAINAGE PIPEIPIT
SYEARS HYDRAULIC GRADE LINE
100 YEARS HYDRAULIC GRADE LINE
DENOTES 20mm CLASS 3
FCR BACKFILL.

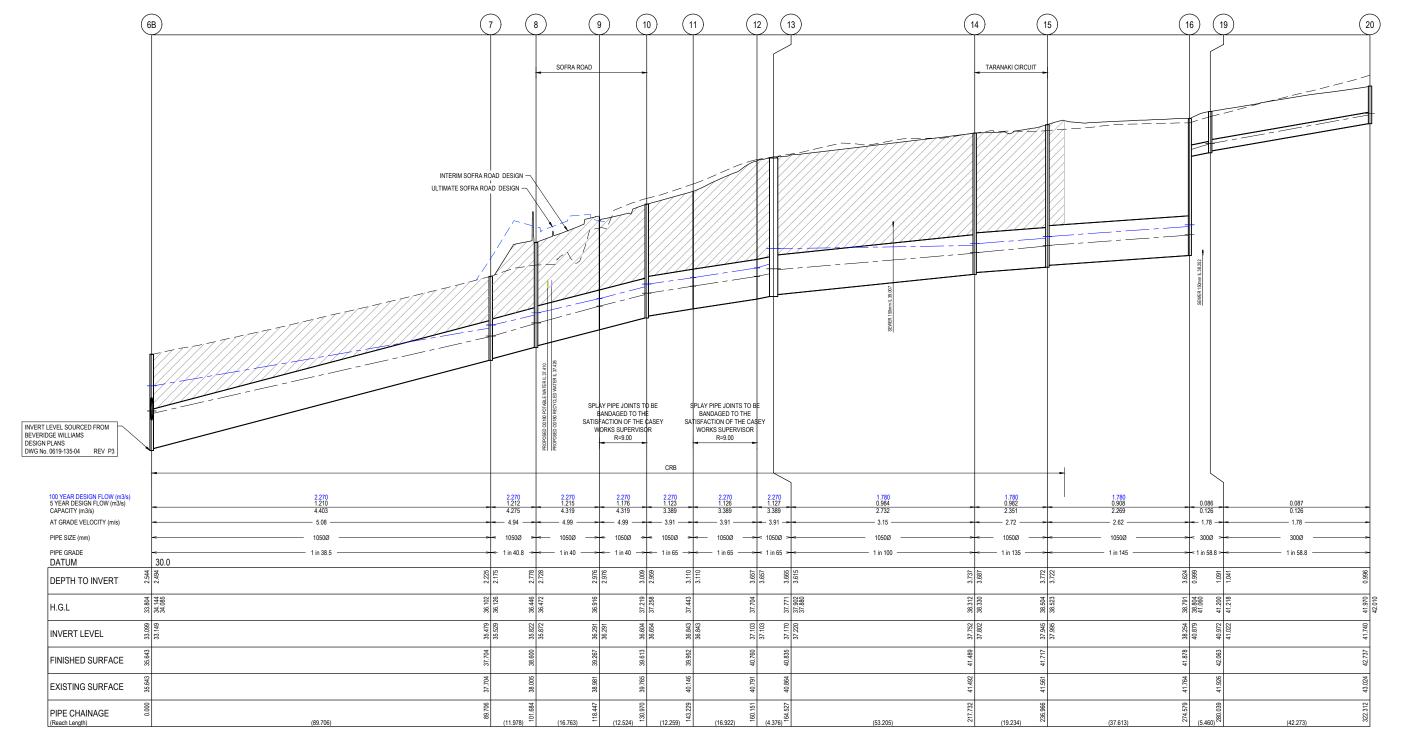

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No unau	uthorised copying is permitted								
В	DRAINAGE BACKFILL HATCH UPDATED	24.08.22	E.B	M.F					
Α	ISSUED FOR CONSTRUCTION	23.08.22	E.B	M.F					
REV	DESCRIPTION	DATE	DRN.	APP.	REV	DESCRIPTION	DATE	DRN.	APP.

BROWN BROWER IN MERILIC CENT





Designed J. TRINH 08.03.2022

30 Drawn N. TABUENA
Approved M. FELICIANO 08.03.2022


PS Number PS848738P


R	Beveridge Williams	i
	1 Glenferrie Road Malwern VIC 3144 ph: 03 9524 8888 www.beveridgewilliams.com.au	1

	•						
Project Details	MERIDIAN CENTRAL ESTATE STAGE 34	Sheet	14 of	17			
	CITY OF CASEY	Scale 1:500 H 1:50 V @ A1					
Drawing Title	DRAINAGE LONGITUDINAL SECTIONS	Project Ref	Stage No	Drawing No			
	(SHEET 1 OF 4)	1801767	34	400			

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В



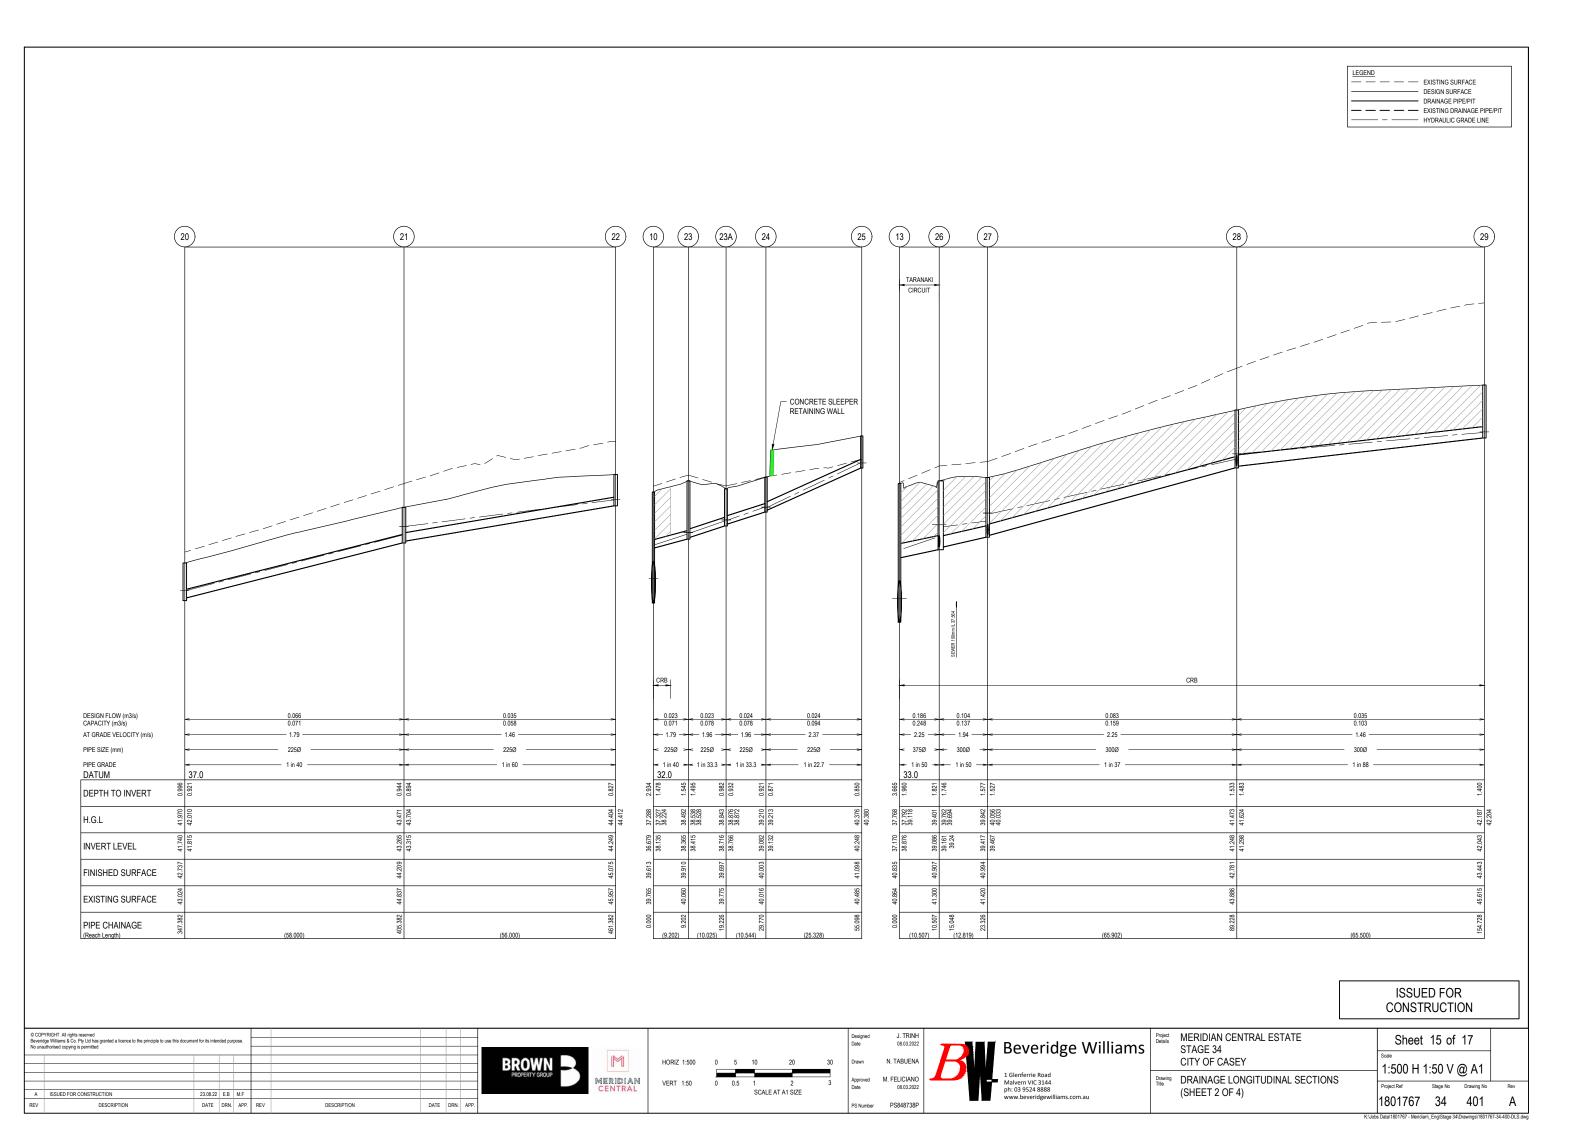

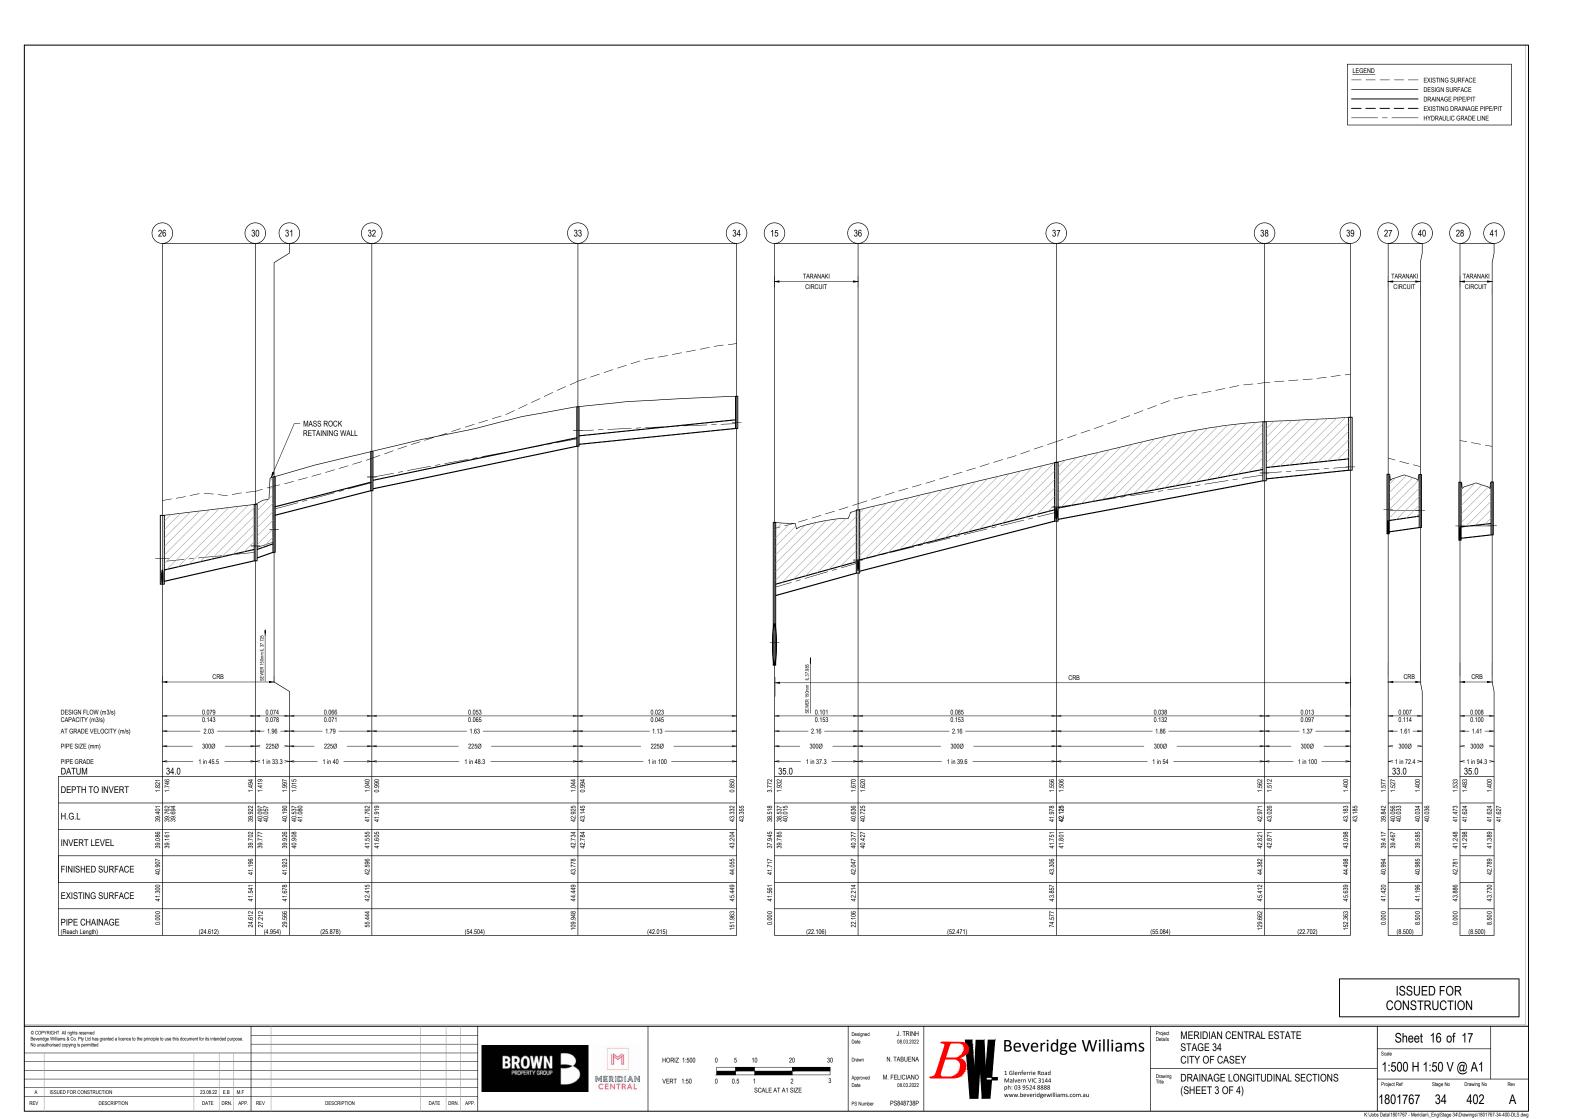LEGEND EXISTING SURFACE
DESIGN SURFACE
DRAINAGE PIPE/PIT
EXISTING DRAINAGE PIPE/PIT
HYDRAULIC GRADE LINE

	-				- 1	,
		CIRCUIT			RANAKI	
]	_		
						-
	-	CRB		-	CRB	1
DESIGN FLOW (m3/s) CAPACITY (m3/s) AT GRADE VELOCITY (m/s)	•	0.007 0.161 - 2.28 -			0.012 0.107	
PIPE SIZE (mm)	<	300Ø >	<u> </u>	٧	300Ø >	
DATUM		1 in 36 > 34.0		36	in 82.1 > 3.0	
DEPTH TO INVERT	1,658	1.400		1.556	1.400	
H.G.L	40.636	40.740	40.742	41.978	42.125	42.133
INVERT LEVEL	40.389	40.678		41.801	41.904	
	42.047	42.078		43.306	43.304	
EXISTING SURFACE	42.214	42.169		43.857	43.727	
PIPE CHAINAGE (Reach Length)	0000	(8.614) (8.614)		0000	8.500) (8.500)	

							PIT SCH	EDULE			
PIT		INTERNAL		INLET		OUTLET		PIT		STD DWG	REMARKS
NAME	TYPE	WD	LEN	DIA	INV LEV	DIA	INV LEV	SETOUT RL	DEPTH		
6	EX. JUNCTION PIT	1350	900	1050	32.092			34.446	2.404		CONNECT INTO EXISTING PIT
6B	JUNCTION PIT	1350	900	1050	33.149	1050	33.099	35.643	2.544	EDCM 605	HAUNCH PIT TO 600 x 900 COVER. PROVIDE HEAVY DUTY COVER
7	JUNCTION PIT	1350	900	1050	35.529	1050	35.479	37.704	2.225	EDCM 605	HAUNCH PIT TO 600 x 900 COVER. PROVIDE HEAVY DUTY COVER
8	JUNCTION PIT	750	1350	1050	35.872	1050	35.822	38.600	2.778	VR SD 1441 & SD 1021	GRATED PIT FOR OPEN GRADED ASPHALT SURFACE. HAUNCH PIT TO 750 x 1000 COVER. PROVI 1m 375dia. STUBE ON WEST WALL IL 36.919 AT 1 in 25.4
9	TP			1050	36.291	1050	36.291	39.267	2.976		
10	GRATED ENTRY PIT	1350	1000	1050	36.654	1050	36.604	39.613	3.009	VR SD 1301	HAUNCH PIT TO 750 x 1000 COVER
				225	38.135						
11	TP			1050	36.843	1050	36.843	39.952	3.11		
12	TP			1050	37.103	1050	37.103	40.760	3.657		
13	DOUBLE GRATED ENTRY PIT	1350	900	1050	37.220	1050	37.170	40.835	3.665	EDCM 602	HAUNCH PIT TO 600 x 900 COVER
				375	38.876						
14	GRATED ENTRY PIT	1350	900	1050	37.802	1050	37.752	41.489	3.737	EDCM 601	HAUNCH PIT TO 600 x 900 COVER
15	JUNCTION PIT	1350	900	1050	37.995	1050	37.945	41.717	3.772	EDCM 608	HAUNCH PIT TO 600 x 900 COVER
				300	39.785						
16	JUNCTION PIT	1350	900	300	40.879	1050	38.254	41.878	3.624	EDCM 608	HAUNCH PIT TO 600 x 900 COVER. PROVIDE BLOCKOUT IN SOUTH WALL FOR FUTURE 1050Ø DRAIN. IL38.304. PROVIDE V-NOTCH ON SOUTH WALL TO COLLECT SWALE DRAIN FLOWS
19	JUNCTION PIT	600	900	300	41.022	300	40.972	42.063	1.091	EDCM 605	
20	JUNCTION PIT	600	900	225	41.815	300	41.740	42.737	0.996	EDCM 605	
21	JUNCTION PIT	600	900	225	43.315	225	43.265	44.209	0.944	EDCM 605	
22	JUNCTION PIT	600	900			225	44.249	45.075	0.827	EDCM 605	
23	JUNCTION PIT	600	900	225	38.415	225	38.365	39.910	1.545	EDCM 605	
23A	JUNCTION PIT	600	900	225	38.766	225	38.716	39.697	0.982	EDCM 605	
24	JUNCTION PIT	600	900	225	39.132	225	39.082	40.003	0.921	EDCM 605	
25	JUNCTION PIT	600	900			225	40.248	41.098	0.850	EDCM 605	
26	DOUBLE GRATED ENTRY PIT	600	900	300	39.161	375	39.086	40.907	1.821	EDCM 602	
				300	39.161						
27	GRATED ENTRY PIT	600	900	300	39.467	300	39.417	40.994	1.577	EDCM 601	
				300	39.467						
28	GRATED ENTRY PIT	600	900	300	41.298	300	41.248	42.781	1.533	EDCM 601	
	-			300	41.298						
29	JUNCTION PIT	600	900		1	300	42.043	43.443	1.400	EDCM 605	
30	GRATED ENTRY PIT	600	900	225	39.777	300	39.702	41.196	1.494	EDCM 601	
31	JUNCTION PIT	600	900	225	40.908	225	39.926	41.923	1.997	EDCM 605	
32	JUNCTION PIT	600	900	225	41.605	225	41.555	42.596	1.040	EDCM 605	
33	JUNCTION PIT	600	900	225	42.784	225	42.734	43.778	1.044	EDCM 605	
34	JUNCTION PIT	600	900	-225	.2.704	225	43.204	44.055	0.850	EDCM 605	
36	GRATED ENTRY PIT	600	900	300	40.427	300	43.204	42.047	1.670	EDCM 601	
30	GIATED ENTITI PIT	000	300	300	40.427	300	40.377	42.047	1.070	FDCIAL OOT	
37	GRATED ENTRY PIT	600	900	300	41.801	300	41.751	43.306	1.556	EDCM 601	
				300	41.801						
38	JUNCTION PIT	600	900	300	42.871	300	42.821	44.382	1.562	EDCM 605	
39	JUNCTION PIT	600	900		1	300	43.098	44.498	1.400	EDCM 605	
40	GRATED ENTRY PIT	600	900			300	39.585	40.985	1.400	EDCM 601	
41	GRATED ENTRY PIT	600	900			300	41.389	42.789	1.400	EDCM 601	
42	GRATED ENTRY PIT	600	900			300	40.678	42.789	1.400	EDCM 601	
43	GRATED ENTRY PIT	600	900			300	41.904	43.304	1.400	EDCM 601	
7.5	GIGIED EIGHT III	000	300	 	-	300	71.507	+5.504	1.400	EDCIVI OUT	

ISSUED FOR CONSTRUCTION

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REV	DESCRIPTION	DATE	DRN.	APP.	REV	DESCRIPTION	DATE	DRN.	APP.







J. TRINH 08.03.2022 N. TABUENA Approved M. FELICIANO Date 08.03.2022



Project Details	MERIDIAN CENTRAL ESTATE STAGE 34 CITY OF CASEY
	OTT OF ONOLE
Drawing Title	DRAINAGE LONGITUDINAL SECTIONS

	MERIDIAN CENTRAL ESTATE STAGE 34	Sheet 17 of 17				
	CITY OF CASEY	1:500 H 1:50 V @ A1				
	DRAINAGE LONGITUDINAL SECTIONS	1.000 11 1.00 7 @ 711				
	(SHEET 4 OF 4)	Project Ref Stage No Drawing No				
	AND PIT SCHEDULE	1801767 34 403				

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